





For Review

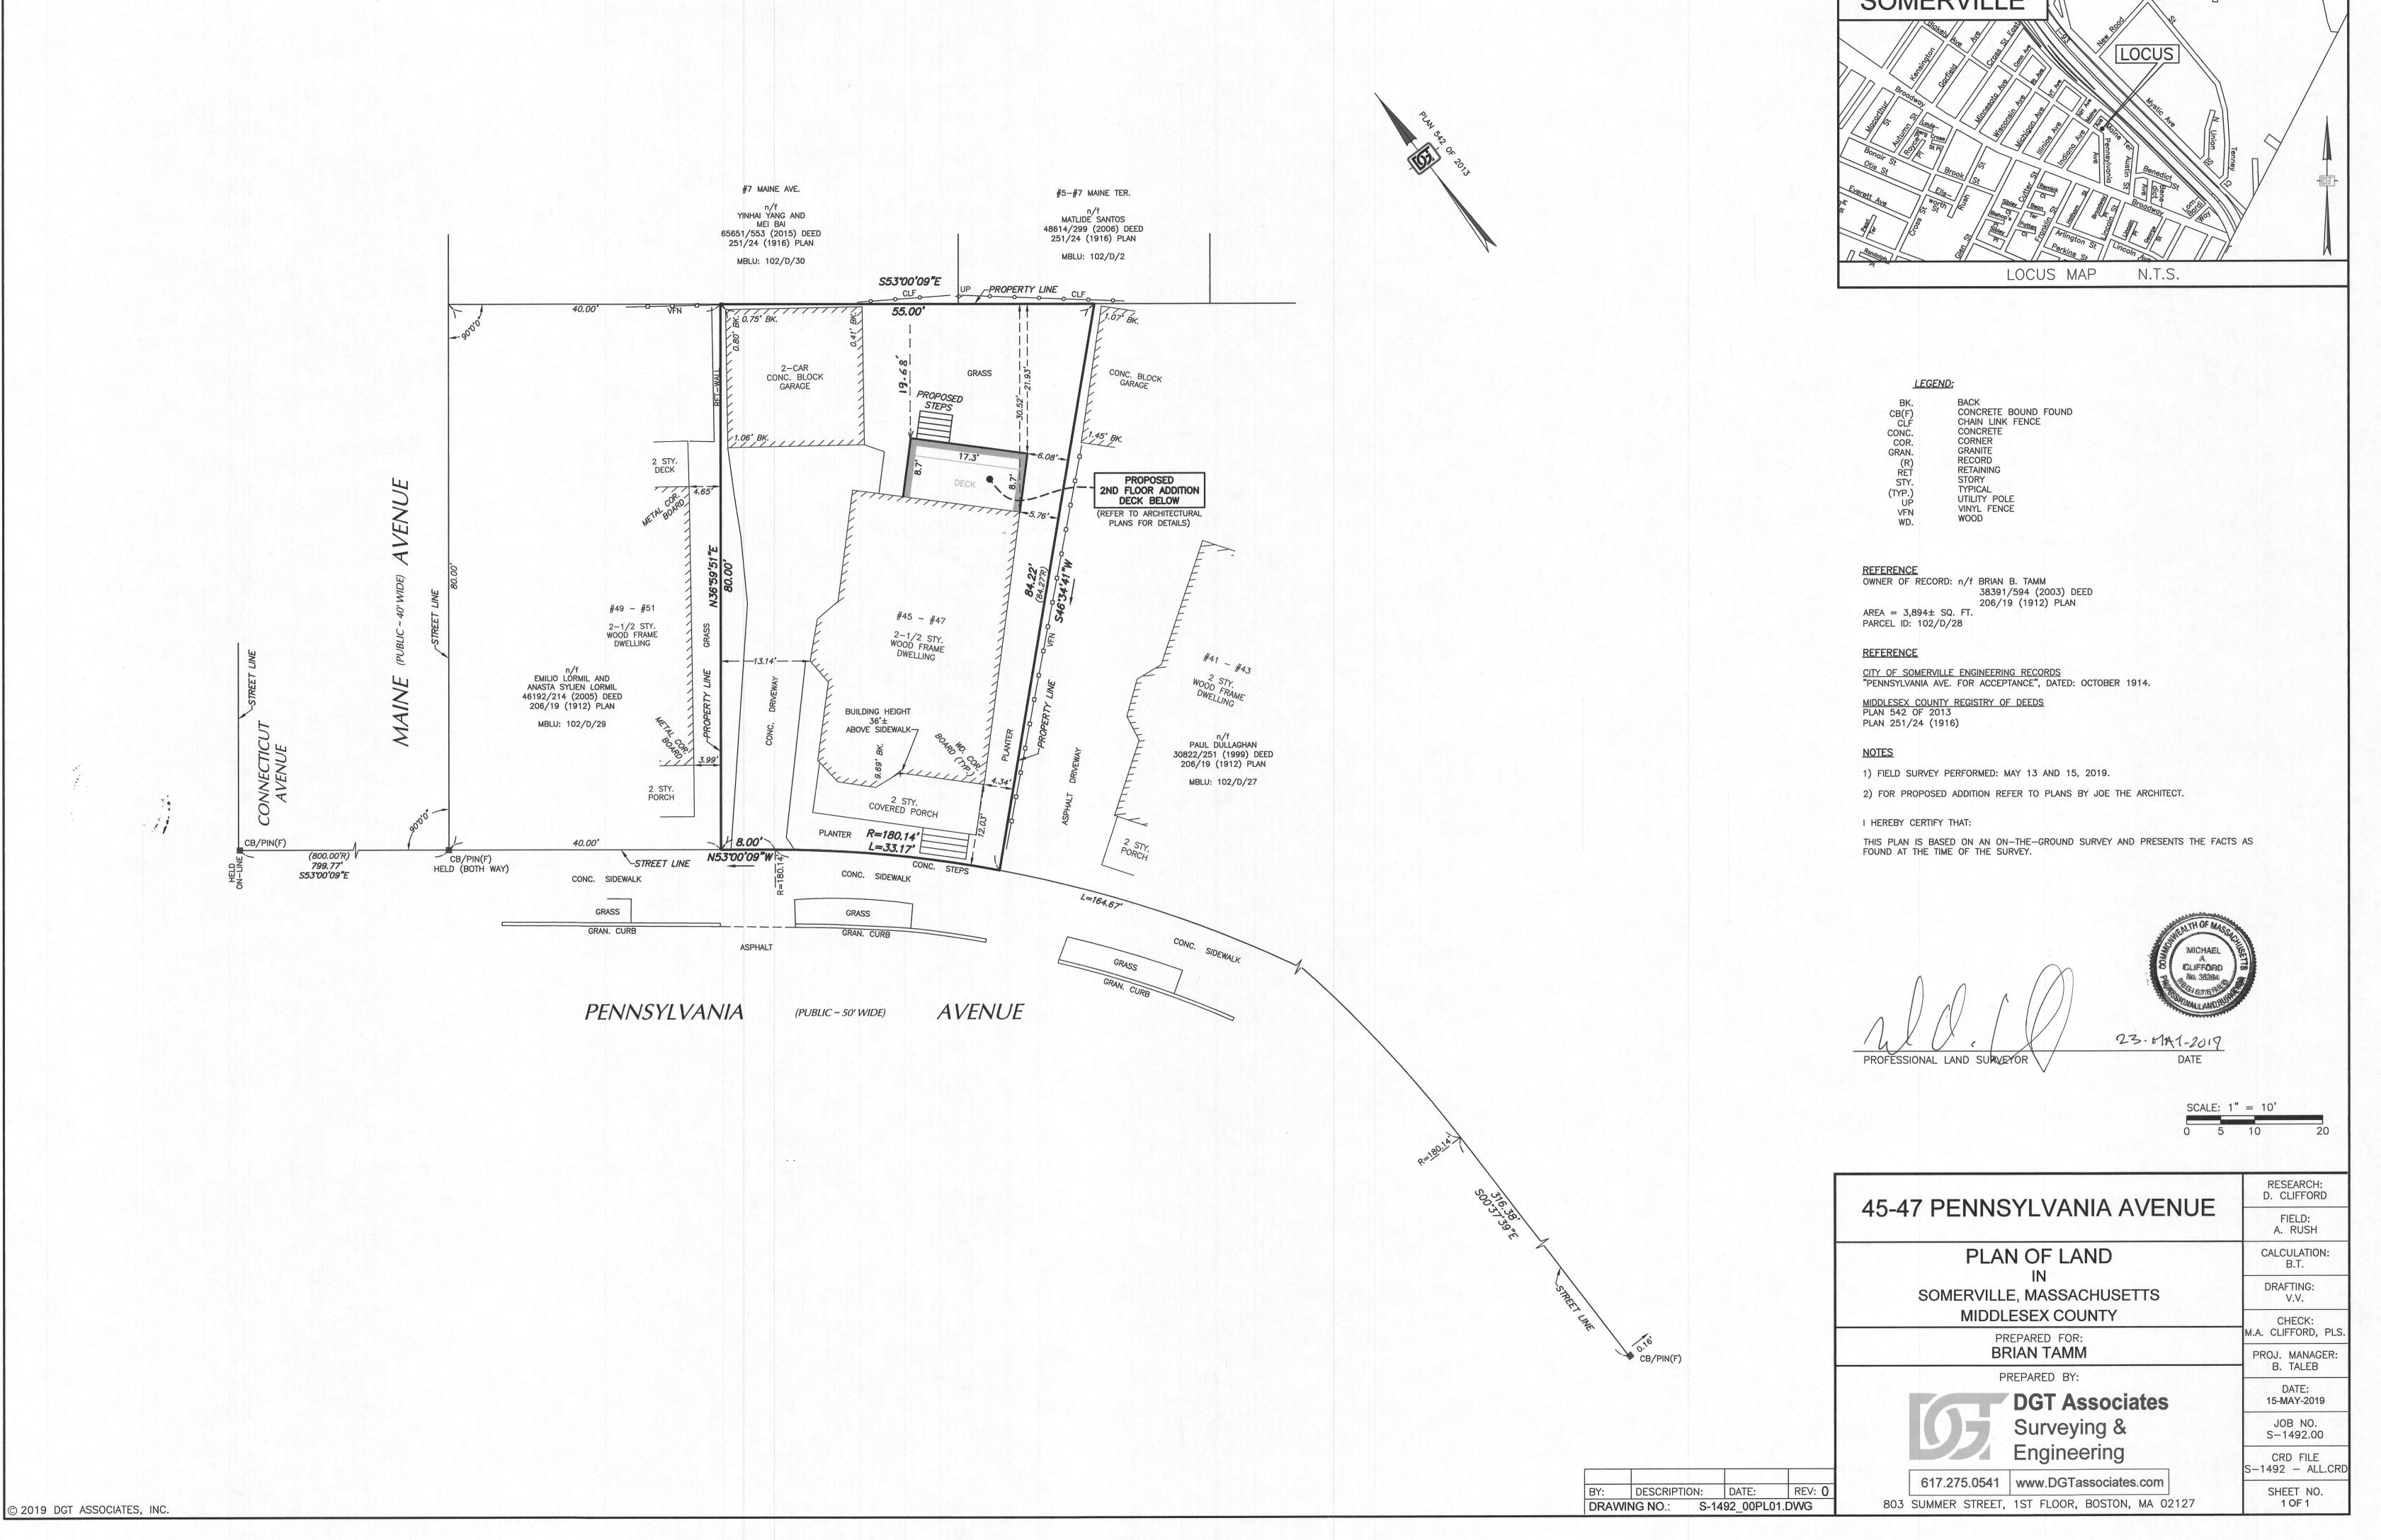


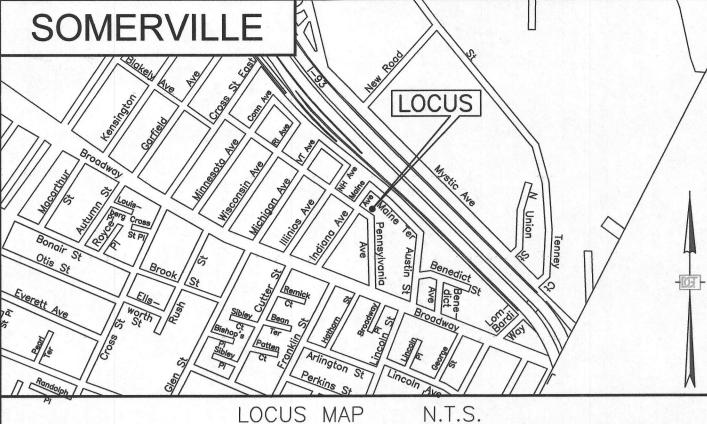

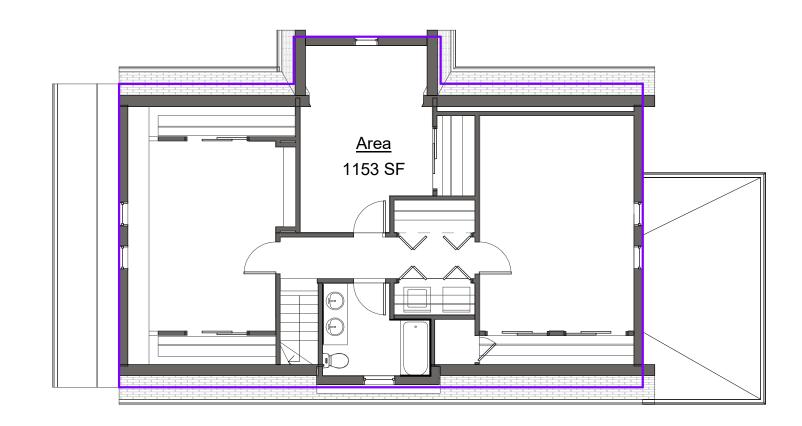


4 THIRD FLOOR GROSS AREA 1,153SF 1/8" = 1'-0"

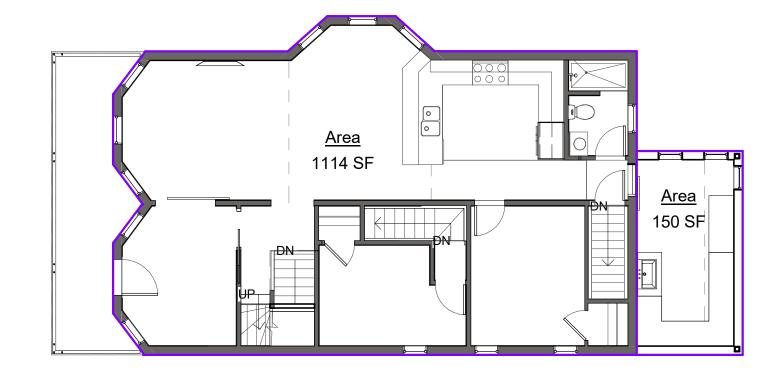

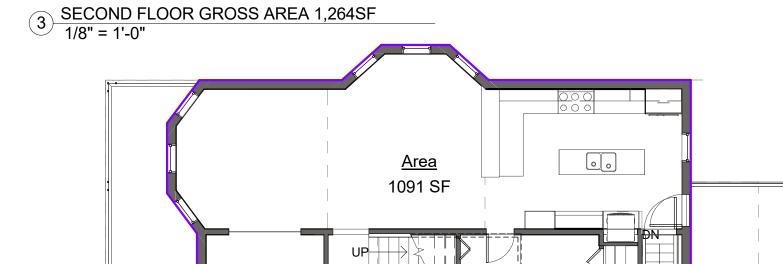


2 FIRST FLOOR GROSS AREA 1,091SF 1/8" = 1'-0"

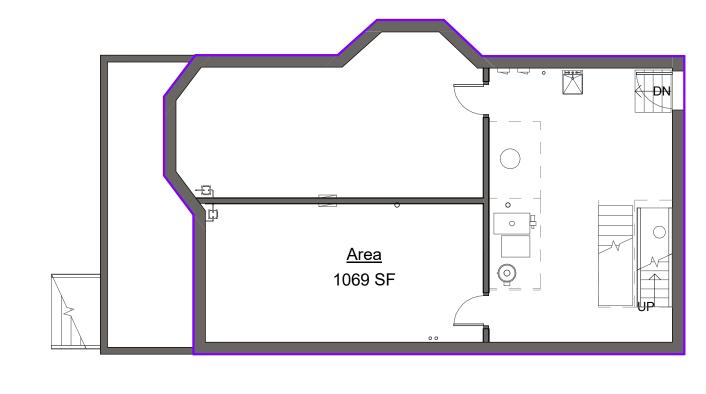


BASEMENT GROSS AREA 1,069SF 1 BASEIVIEINI C 1/8" = 1'-0"

GROSS AREA DIAGRAMS


TOTAL GROSS FLOOR AREAS EXISTING: 4,427 SF PROPOSED: 4,577SF

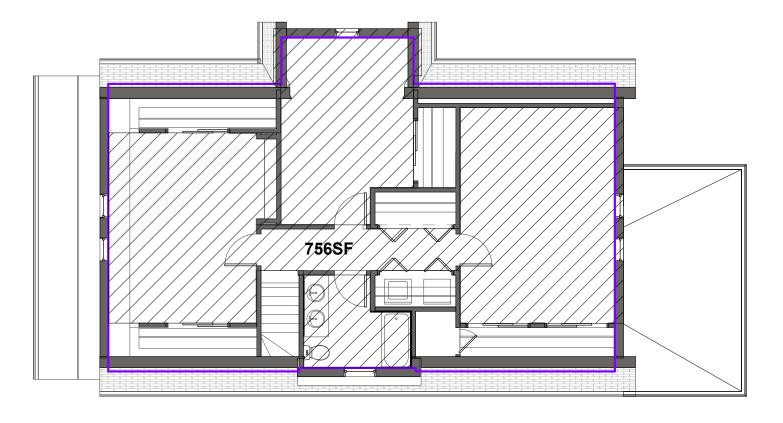


8 THIRD FLOOR NET AREA 756SF 1/8" = 1'-0"

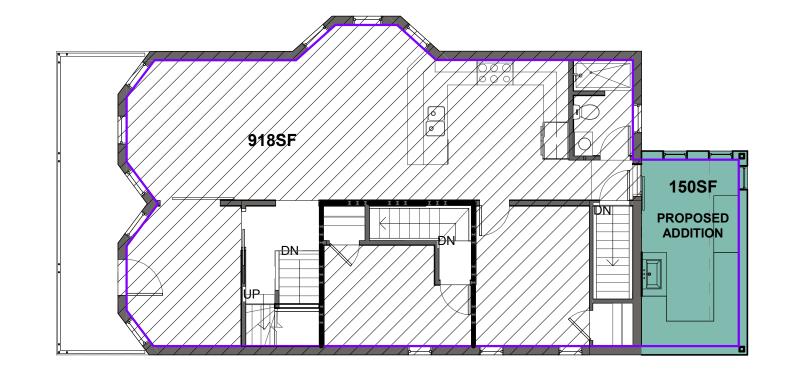

7 SECOND FLOOR NET AREA 918SF 1/8" = 1'-0"

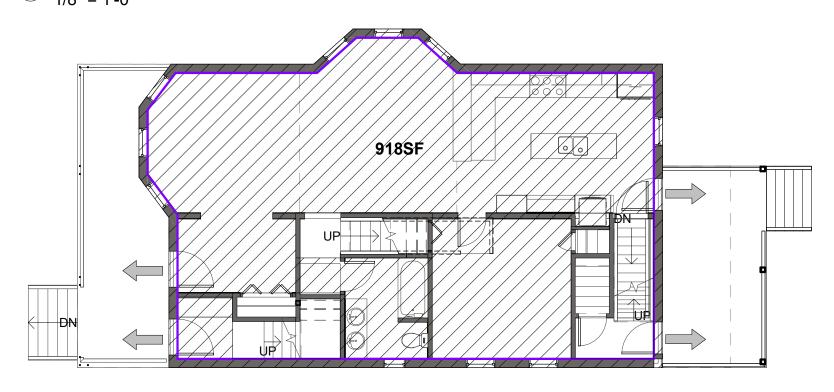

6 FIRST FLOOR NET AREA 918SF 1/8" = 1'-0"

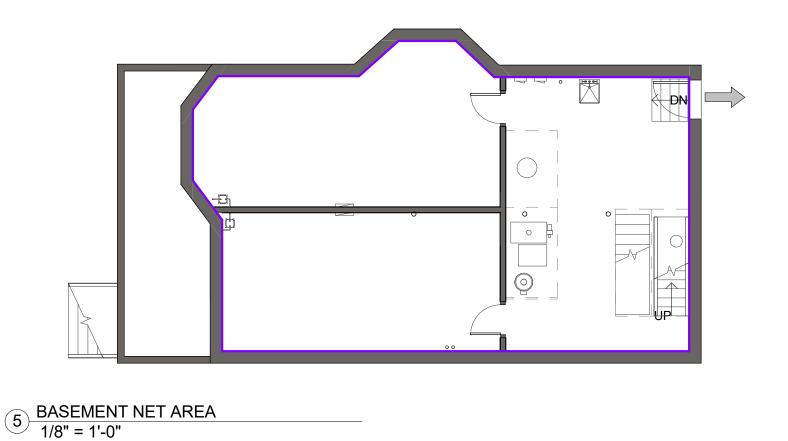

NET AREA DIAGRAMS

TOTAL NET FLOOR AREAS EXISTING: 2,592SF PROPOSED: 2,742SF

PROJECT DATA	
PROPERTY CLASS	TWO FAMILY
MAP/LOT	8/K/10
NEIGHBORHOOD	0000 - RA
CITY OF SOMEDVII I E 70N	INC OPDINANCE (AS AMMENDED NOVEMBED 26 2013)

CITY OF SOMERVILLE ZONING ORDINANCE (AS AMMENDED NOVEMBER 26,2013)


APPLICABLE CODE	S & REGULATIONS
BUILDING	-780 CMR Massachusetts state building code (MSBC) 9th edition -international building code (ibc) 2015
ENERGY	-International energy conservation code (IECC) 2015, with MA amendments
PLUMBING	-248 CMR 10.00 Massachusetts uniform state plumbing code -Massachusetts general law (MGL) chapter 128 section 26G (auto sprinkler systems)

ACCESSIBILITY -521 CMR Massachusetts Architectural Access Board (MAAB) 1/27/06 - 2010 American Disability Act (ADA) standards									
SECTION 8.5 TABLE OF DIMENSIONAL REQUIREMENTS - CITY OF SOMERVILLE									
		REQUIRED	EXISTING	PROPOSED					
MINIMUM LOT SIZE		10,000 SF	3,894 SF	3,894 SF					
MINIMUM LOT AREA D	WELLING/UNIT	2,250 SF	1,947 SF	1,947 SF					
MAXIMUM GROUND C	OVERAGE	50%	36%	36%					
LANDSCAPED AREA (MIN % OF LOT)	25%	36%	36%					
GROSS FLOOR AREA			4,427	4,577					
NET FLOOR AREA			2,592	2,742					
FLOOR AREA RATIO (F	FAR)*	75%	66%	70%					
MAXIMUM BUILDING H	EIGHT	35 FT	35 FT	35 FT					
MAXIMUM STORIES		2 1/2	2 1/2	2 1/2					
MINIMUM FRONT YARI)	15'-0"	9'-8"	9'-8"					
MINIMUM SIDE YARD SETBACK WITH REDUCTION OF SIDE	LEAST WIDTH OF SIDE YARD	7' - 3"	4' - 0"	4' - 0"					
YARD FOR NARROW LOTS *(10)	SUM WITH BOTH SIDE YARD	15' - 6"	17' - 6"	17' - 6"					
MINIMUM REAR YARD	*(13)	15' - 0"	25' - 10"	25' - 10"					
MINIMUM FRONTAGE		50 FT	41 FT	41 FT					
PERVIOUS AREA (MIN	% OF LOT)	35%	37%	35%					

*SECTION 8.5 TABLE OF DIMENSIONAL REQUIREMENTS FOOTNOTES 10 & 13

BASEMENT SQUARE FOOTAGE IS NOT INCLUDED IN FAR CALCULATIONS

CONTRACTOR SHALL CONFORM TO ALL CODES, ORDINANCES ETC. AND RETAIN RESPONSIBILITY FOR JURISDICTION OVER THE WORK. ALL WORK SHALL COMPLY WITH LATEST REVISIONS OF ALL APPLICABLE CODES AND ORDINANCES INCLUDING THE FOLLOWING:

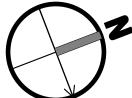

PROJECT ROSTER

CLIENT
Brian Tamm & Nancy Campbell 47 Pennsylvania Avenue Somerville, MA 02145

ARCHITECTURE Alex Siekierski Project Manager Joe The Architect, LLC 343 Medford Street, 4C Somerville, MA 02145 Phone: 617-764-3593 alex@joethearchitect.com

STRUCTURE
Carmine Guarracino, P.E.

Principal Roome & Guarracino LLC 48 Grove Street Somerville, MA 02144 Phone: 617-628-1700x202 Guarracino@RGEng.com

CONTRACTOR

D&R Construction Company

OWNER Eric Dutra 52 Berkshire Street. Cambridge, MA 02141 617-378-8975 ericdutra@dandrconstructionco.com

For Review


WARNING:

Joe The Architect, Inc., all drawings and written material herein constitute the original and unpublished work of the architect, and the same may not be duplicated, used, or disclosed without the written consent of the architect. Contractors to use Architectural drawings for set out. Contractors to check and verify all Dimensions on Site prior to Construction/Fabrication. Figured Dimensions take precedence over Scaled Dimensions. Any discrepancies should be immediately referred to the Architect. The project manager shall be notified in writing of any discrepancies prior. Architect. The project manager shall be notified in writing of any discrepancies prior to proceeding with the work. The scale of drawings may change when copied or faxed. All work to comply with I.B.C. Regulations and relevant American Standards. © 2019- all rights reserved

consultant / contractor information: D&R Construction Company

Eric Dutra 52 Berkshire St. Cambridge, MA 02141

617-378-8975 ericdutra@dandrconstructionco.com

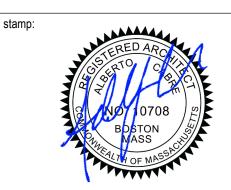

ision	revision description	date
	FOR PERMIT	03/27/2019
	FOR APPROVAL	05/24/2019
	FOR APPROVAL R1	07/17/2019

PENNSYLVANIA AVENUE SOMERVILLE

47 Pennsylvania Ave Somerville, MA 02145

client information: **BRIAN TAMM &** NANCY CAMPBELL


47 Pennsylvania Avenue Somerville, MA 02145




JOE THE ARCHITECT 343 Medford Street, Suite 4C, Somerville, MA 02145 t: +1(617) 764-3593 | e: askjoe@joethearchitect.com www.joethearchitect.com

drawing title CODES/REGULATIONS **AND AREA PLANS**


2.	project number	drawing scale	appr
	116	As indicated	Appr
	drawing number	•	revisi

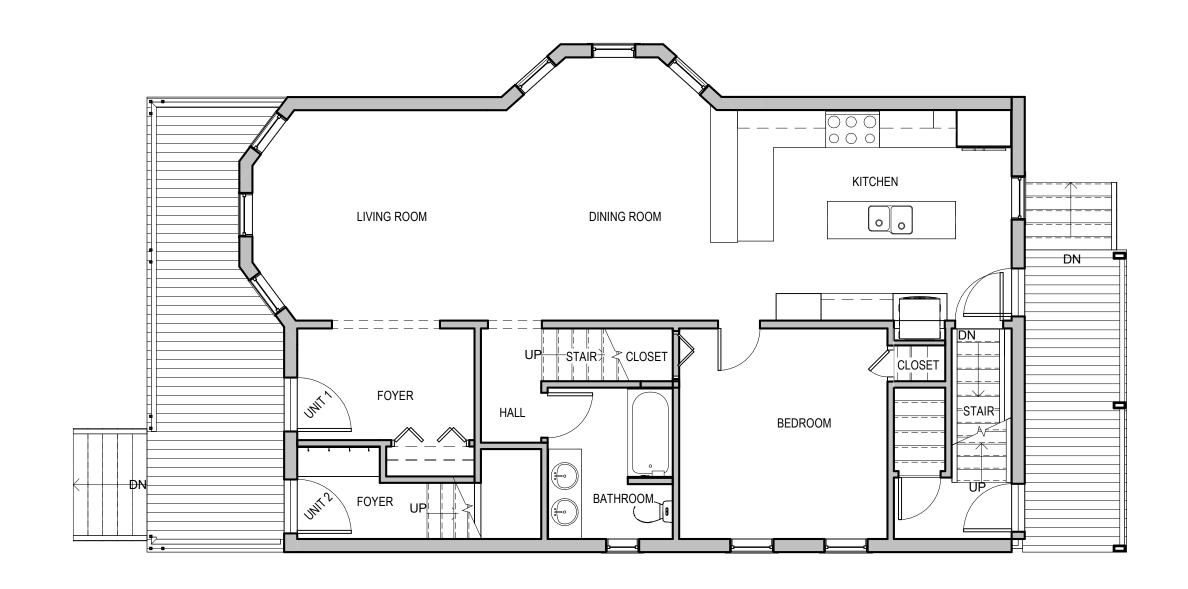


2 EXISTING FIRST FLOOR PLAN 3/16" = 1'-0"

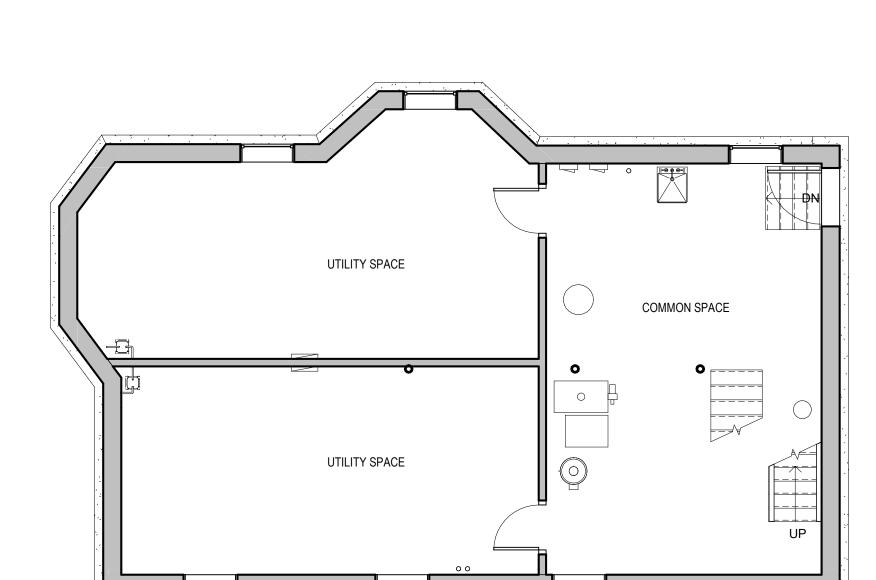


1 EXISTING BASEMENT PLAN 3/16" = 1'-0"

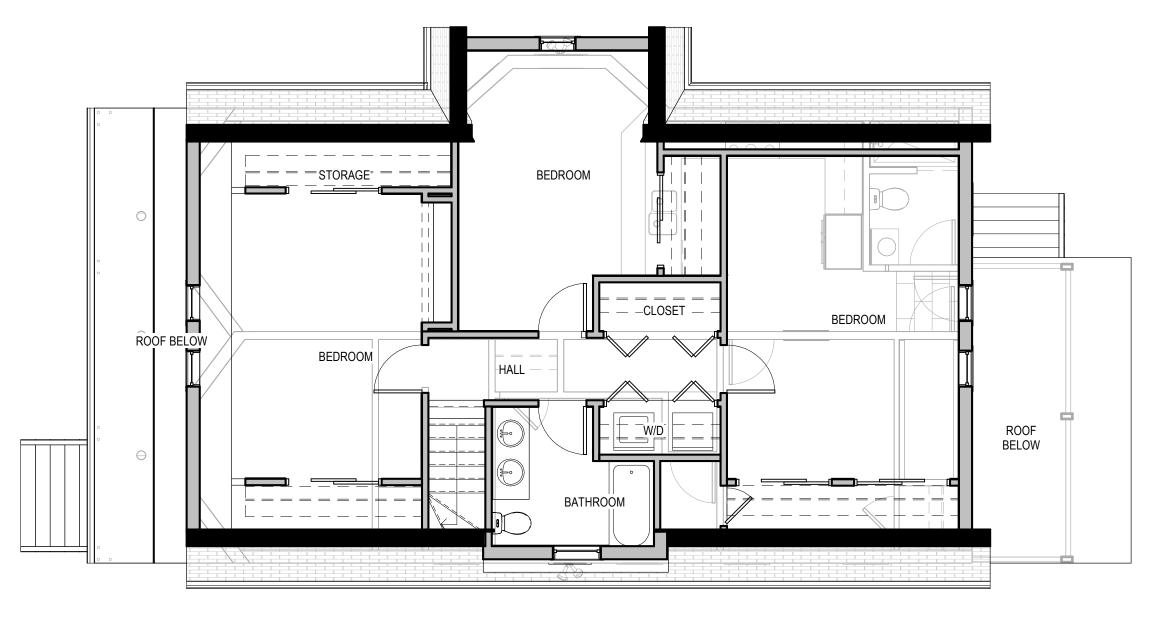

4 EXISTING THIRD FLOOR 3/16" = 1'-0"

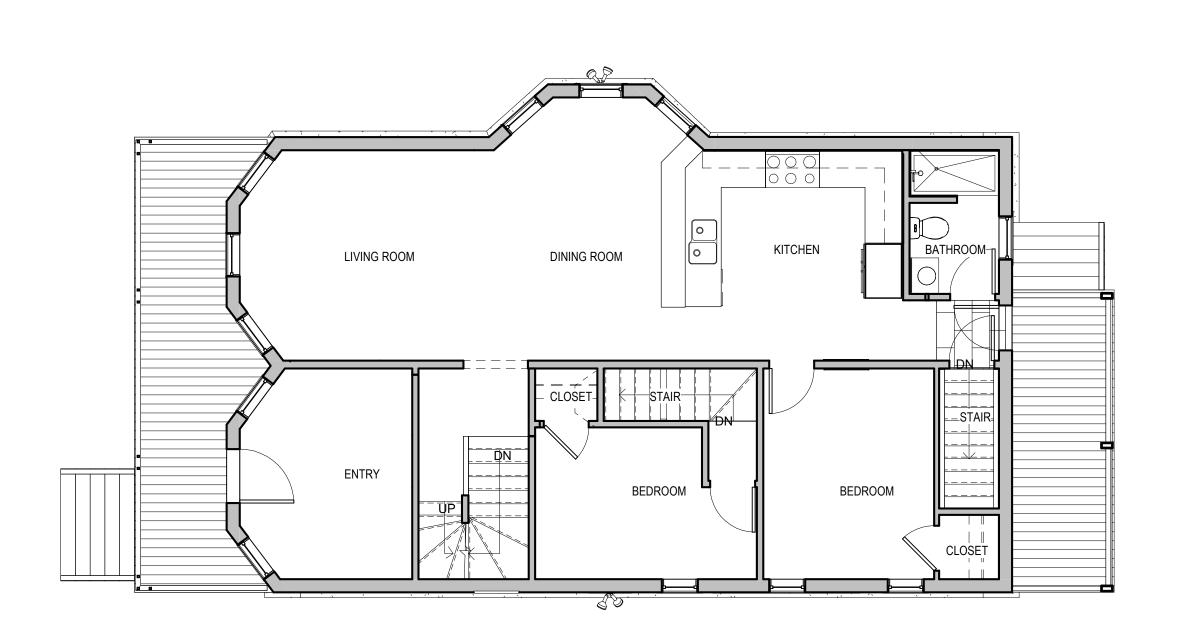

3 EXISTING SECOND FLOOR
3/16" = 1'-0"

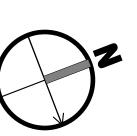



existing full height solid, glazed or part glazed partition to remain.

existing full height solid, glazed or part glazed partition to be demolished

new full height solid, glazed or part glazed partition to be demolished

existing door to be demolished

existing wall finish to be removed, to be read in conjunction with proposed works

existing door to remain new door

demolition hatch

partial area demolition

NIC - Not In Constract Hatch

For Review

WARNING:


Joe The Architect, Inc., all drawings and written material herein constitute the original and unpublished work of the architect, and the same may not be duplicated, used, or disclosed without the written consent of the architect. Contractors to use Architectural drawings for set out. Contractors to check and verify all Dimensions on Site prior to Construction/Fabrication. Figured Dimensions take precedence over Scaled Dimensions. Any discrepancies should be immediately referred to the Architect. The project manager shall be notified in writing of any discrepancies prior. Architect. The project manager shall be notified in writing of any discrepancies prior to proceeding with the work. The scale of drawings may change when copied or faxed. All work to comply with I.B.C. Regulations and relevant American Standards. © 2019- all rights reserved

consultant / contractor information: D&R Construction Company

Eric Dutra

52 Berkshire St. Cambridge, MA 02141

617-378-8975 ericdutra@dandrconstructionco.com

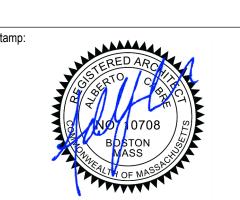

FOR APPROVAL 05/24/2019 FOR APPROVAL R1 07/17/2019

PENNSYLVANIA AVENUE SOMERVILLE

47 Pennsylvania Ave Somerville, MA 02145

BRIAN TAMM & NANCY CAMPBELL

client information:

47 Pennsylvania Avenue Somerville, MA 02145



JOE THE ARCHITECT 343 Medford Street, Suite 4C, Somerville, MA 02145 t: +1(617) 764-3593 | e: askjoe@joethearchitect.com www.joethearchitect.com

drawing title **EXISTING PLANS**

drawing scale approver As indicated Approver

GENERAL DEMO NOTES:

- give a general scope. 2. All existing lights, including any lights not shown on
- 3. Contractor to follow the required code or approved removal procedures of asbestos, lead, and other
- hazardous materials remediation. 4. See Fire Protection, Plumbing, Mechanical, and Electrical drawings for locations of any new ducts, pipes, or components that require new penetrations through existing beams, bearing walls, and all other partitions and floors. See structural drawings for criteria for new openings through structural walls, beams,
- floors, and roofs, and through masonry partitions 5. All existing fire protection, plumbing, and electrical items that are or will be made inactive in the scope of this project, including existing abandoned items within accessible locations, shall be removed in the scope of this project.
- Existing interior doors to be removed and replaced, where noted.

- 1. Light fixtures indicated are an approximate quantity to
- these plans, are to be removed unless noted otherwise.
- to be demolished C = = 3 existing door to be demolished

to remain.

existing wall finish to be removed, to be read in

conjunction with proposed works

review demolition scope in association with proposed works to accurately determine the extent of demolition and the extent of works to be retained. over demolition shall be reinstated at no cost to the

DEMOLITION LEGEND:

existing full height solid, glazed or part glazed partition

existing full height solid, glazed or part glazed partition


full roof area demolition

partial roof area demolition


WARNING:
Joe The Architect, Inc., all drawings and written material herein constitute the

original and unpublished work of the architect, and the same may not be duplicated, used, or disclosed without the written consent of the architect. Contractors to use


For Review

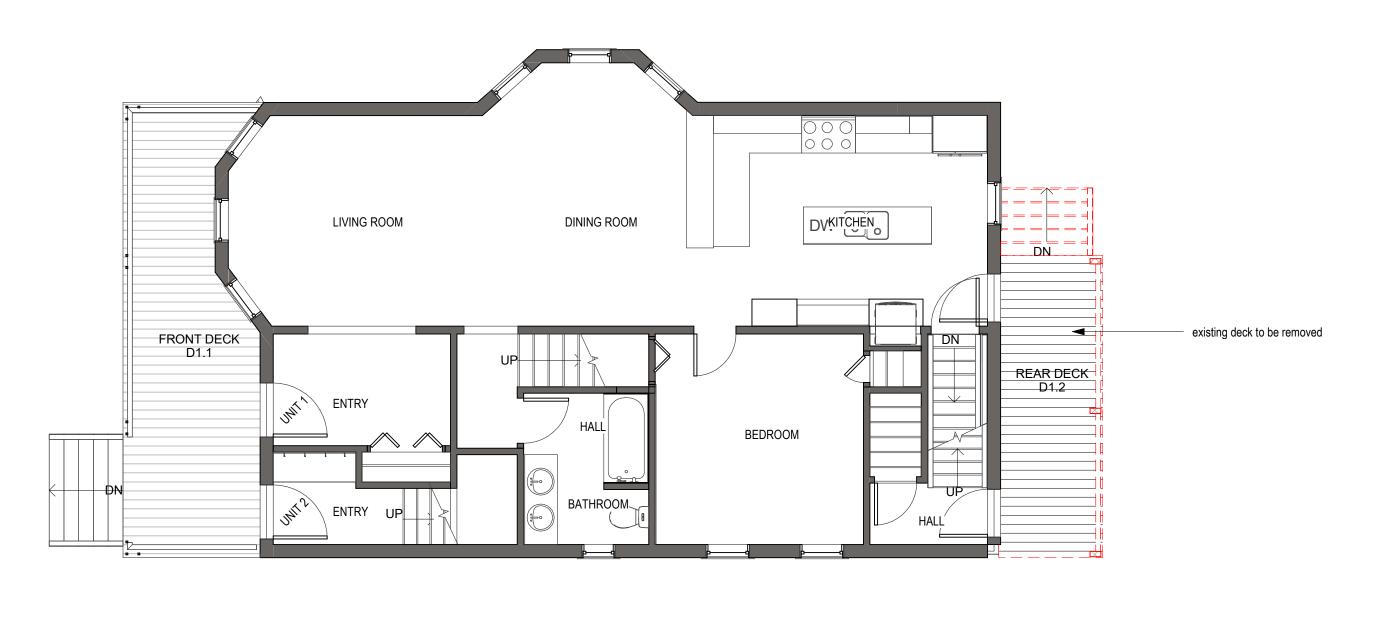


2 FIRST FLOOR DEMOLITION PLAN
3/16" = 1'-0"

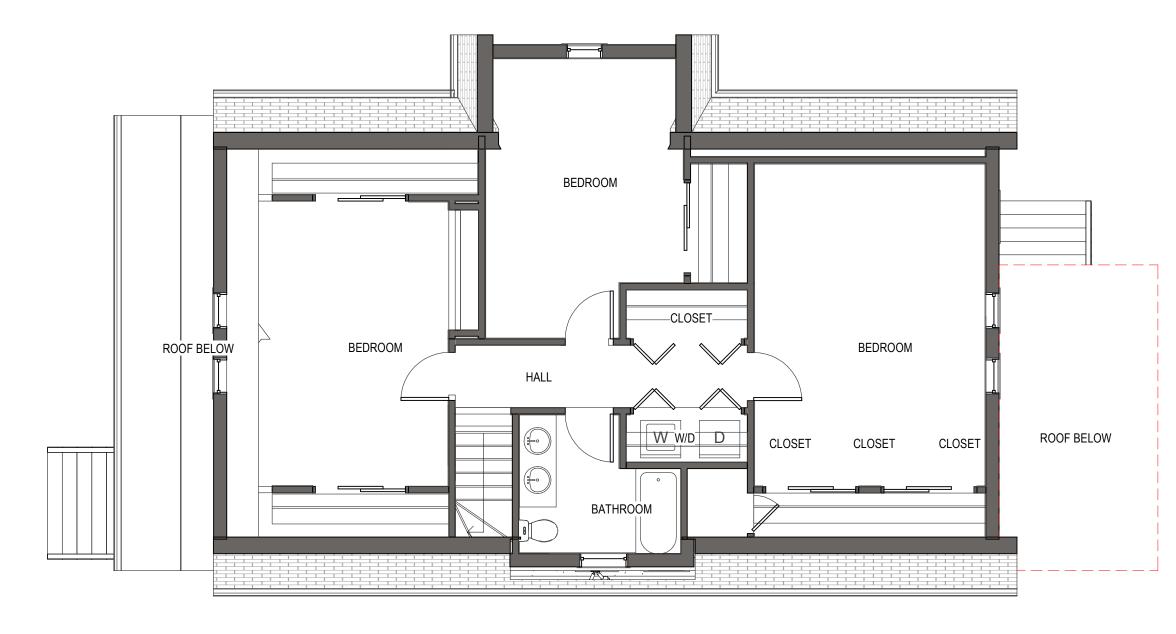


4 THIRD FLOOR DEMOLITION PLAN
3/16" = 1'-0"

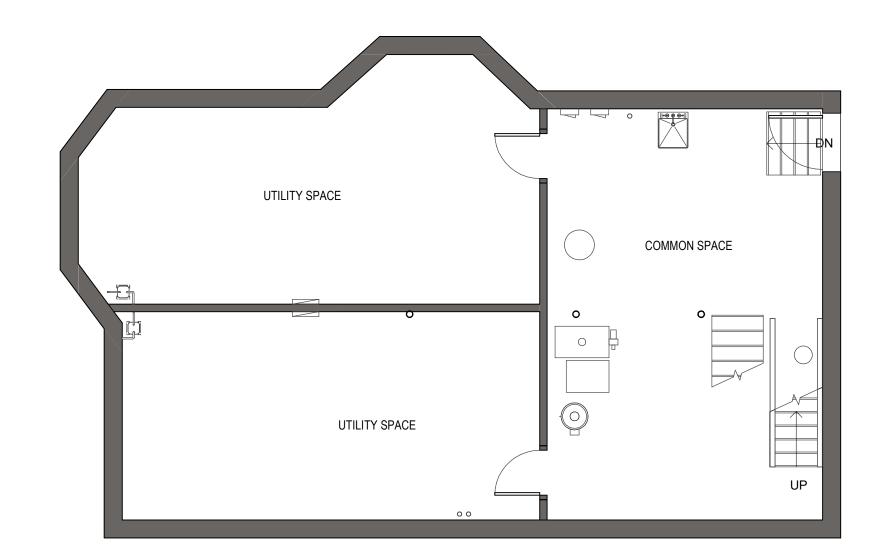

1 BASEMENT DEMOLITION PLAN
3/16" = 1'-0"

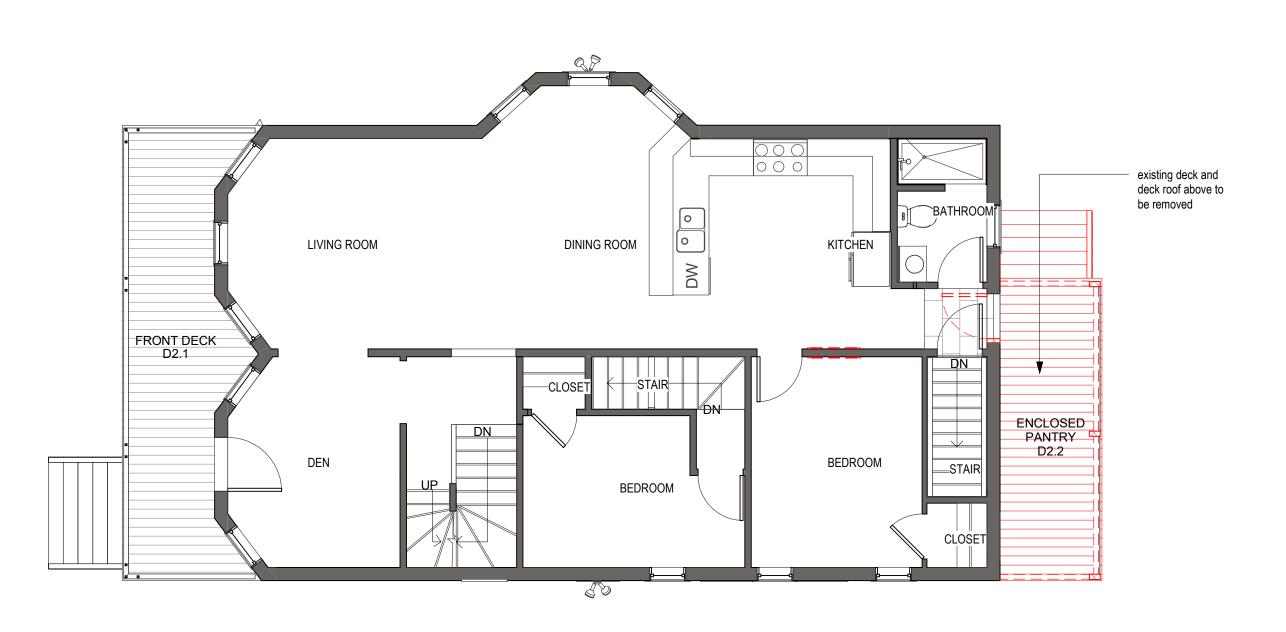

3 SECOND FLOOR DEMOLITION PLAN
3/16" = 1'-0"

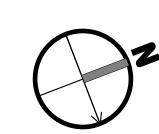




DEMOLITION PLANS

drawing scale approver As indicated Approver





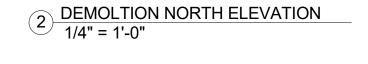



DEMOLITION LEGEND:

existing full height solid, glazed or part glazed partition to remain.

Roof 31' - 2 3/4"

existing full height solid, glazed or part glazed partition to be demolished C = = 3

existing door to be demolished

existing wall finish to be removed, to be read in conjunction with proposed works _____

review demolition scope in association with proposed works to accurately determine the extent of demolition and the extent of works to be retained. over demolition shall be reinstated at no cost to the proprietor.

full roof area demolition partial roof area demolition

For Review

oe The Architect, Inc., all drawings and written material herein constitute the original and unpublished work of the architect, and the same may not be duplicated, used, or disclosed without the written consent of the architect. Contractors to use Architectural drawings for set out. Contractors to check and verify all Dimensions on Site prior to Construction/Fabrication. Figured Dimensions take precedence over aled Dimensions. Any discrepancies should be immediately referred to the Architect. The project manager shall be notified in writing of any discrepancies prior to proceeding with the work. The scale of drawings may change when copied or faxed. All work to comply with I.B.C. Regulations and relevant American Standards. © 2019- all rights reserved

consultant / contractor information:

D&R Construction Company

Eric Dutra

52 Berkshire St. Cambridge, MA 02141 617-378-8975

ericdutra@dandrconstructionco.com

FOR APPROVAL 05/24/2019 FOR APPROVAL R1 07/17/2019

PENNSYLVANIA AVENUE SOMERVILLE

47 Pennsylvania Ave Somerville, MA 02145

client information: **BRIAN TAMM &** NANCY CAMPBELL

47 Pennsylvania Avenue Somerville, MA 02145

JOE THE ARCHITECT 343 Medford Street, Suite 4C, Somerville, MA 02145 t: +1(617) 764-3593 | e: askjoe@joethearchitect.com


www.joethearchitect.com

drawing title DEMOLITION **ELEVATIONS**

As indicated | Approver

drawing number

1 FIRST FLOOR PLAN 3/8" = 1'-0"

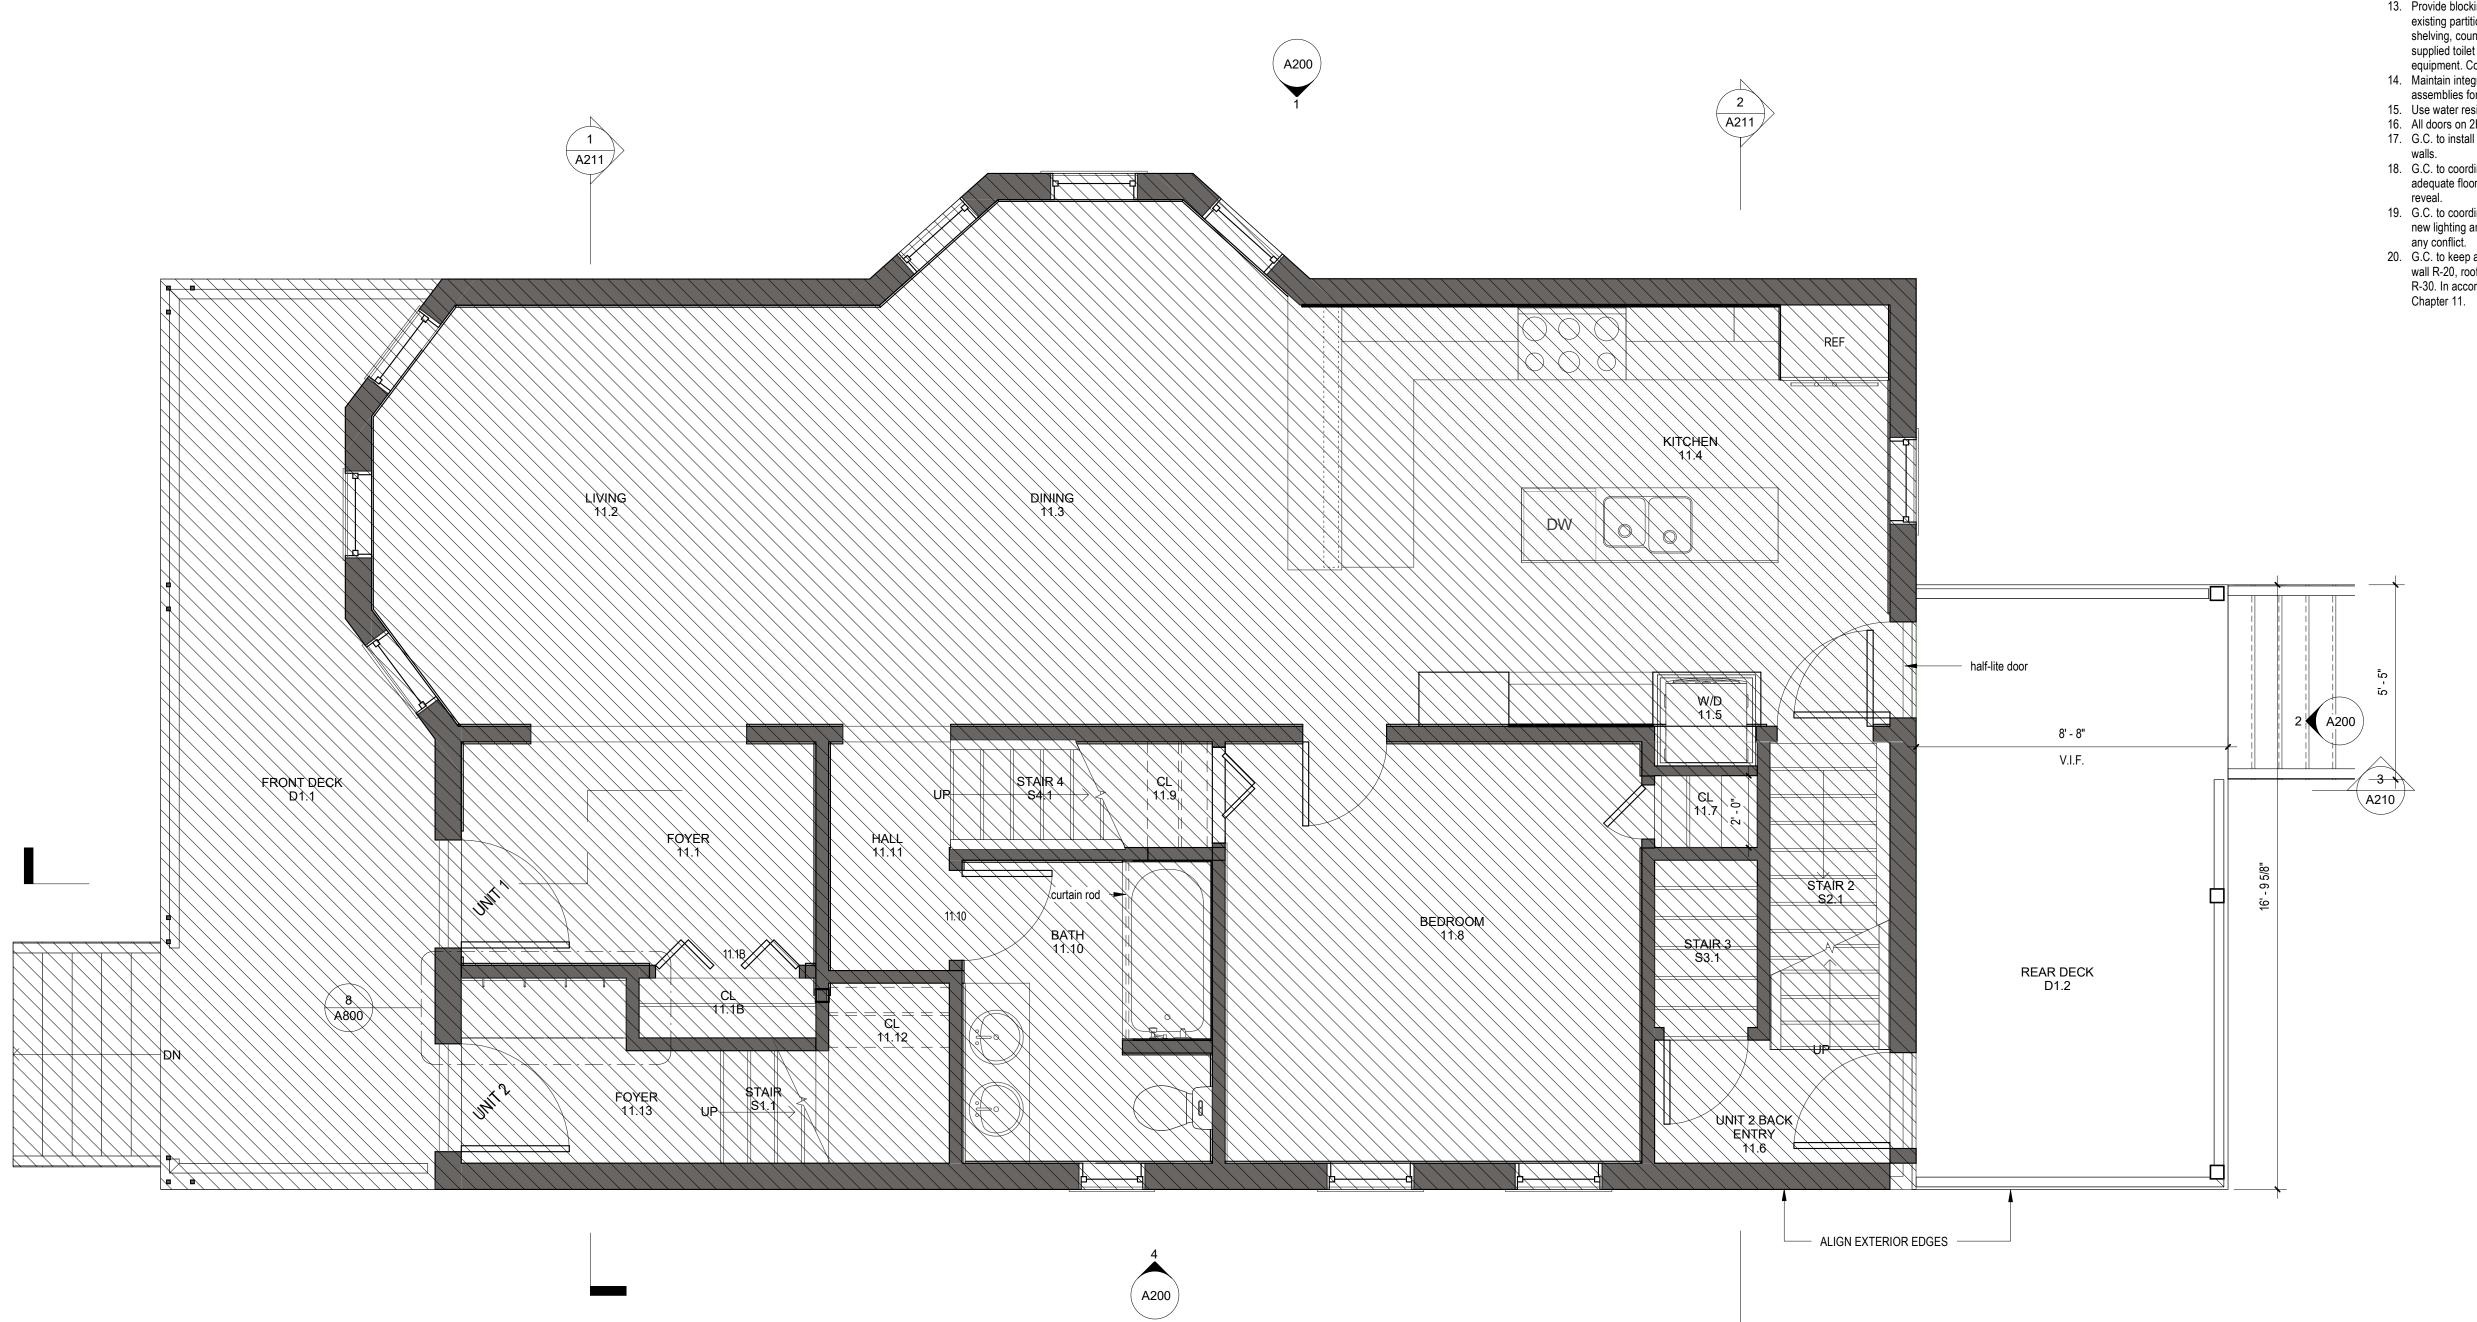

Construction Notes

- 1. See sheet A001 for abbreviations and typical mounting heights.
- 2. See sheet A440 for partition type schedule and
- information 3. Use type GWB on fire rated partitions.
- 4. Keep door frames 4" clear on hinge side at all partition intersections except at columns where clearance is provided for hardware.
- 5. Use cementitious backer board ('Durock') or equal at partitions scheduled to receive tile. See finish plan for location of tile.
- 6. Where furred partitions exceed maximum height, brace to adjacent structure.
- 7. Provide level 5 finish at all partitions to receive wall
- 8. Provide level 4 finish at all interior partitions.
- 9. Provide flush drywall type access panels in partitions
- as required for service of building systems. 10. Dimensioning: All partition dimensions shown are to face of finish. - Dimensions noted as "CLEAR." mean clear dimension to face of finish. -Dimensions noted as "R.O." mean dimension of clear rough opening between studs. - All horizontal dimensions are shown on plans and vertical dimensions on interior & exterior elevations where relevant. - Vertical dimensions are too top of subfloor. See door schedule for door sizes,
- frame and details. 11. Align vertically & horizontally electrical wall devices including switches, outlets, fire alarm devices, exit signs, emergency lights, etc. When possible within code requirements, and where near each other.
- 12. See RCP for info regarding ceiling type finish, fixtures and all ceiling information.
- 13. Provide blocking and backing as required within existing partitions and new partitions for all casework, shelving, countertops, toilet accessories, and owner supplied toilet accessories, and owner supplied equipment. Coordinate with shop drawings.
- 14. Maintain integrity of existing fire resistant rated assemblies for all penetrations.
- 15. Use water resistance GWB on all wet areas. 16. All doors on 2H rated walls to be 1 1/2" rated door.
- 17. G.C. to install acoustic insulation on all interior new
- 18. G.C. to coordinate all floor transition thickness with adequate floor thresholds that do not exceed 1/2"
- 19. G.C. to coordinate HVAC systems distribution with new lighting and ceiling layout contact architect with
- 20. G.C. to keep a continuous building thermal envelop wall R-20, roof R-38, basement wall R-10, floor R-30. In accordance with IBC energy efficiency Chapter 11.

Construction Legend


existing full height solid, glazed or part glazed partition to remain.

existing full height solid, glazed or part glazed partition to be demolished E = = 3

new full height solid, glazed or part glazed partition to be demolished

existing door to be demolished

existing wall finish to be removed, to be read in conjunction with proposed works

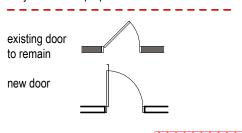

demolition hatch partial area demolition

NIC - Not In Constract Hatch


For Review

WARNING:
Joe The Architect, Inc., all drawings and written material herein constitute the original and unpublished work of the architect, and the same may not be duplicated, used, or disclosed without the written consent of the architect. Contractors to use itectural drawings for set out. Contractors to check and verify all Dimensions on Site prior to Construction/Fabrication. Figured Dimensions take precedence over aled Dimensions. Any discrepancies should be immediately referred to the Architect. The project manager shall be notified in writing of any discrepancies prior o proceeding with the work. The scale of drawings may change when copied or faxed. All work to comply with I.B.C. Regulations and relevant American Standards. © 2019- all rights reserved

consultant / contractor information: D&R Construction Company

Eric Dutra 52 Berkshire St. Cambridge, MA 02141 617-378-8975

ericdutra@dandrconstructionco.com

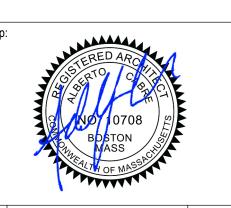

revision description 12/05/2018 Meeting Revision FOR APPROVAL 05/24/2019 FOR APPROVAL R1 07/17/2019

PENNSYLVANIA AVENUE SOMERVILLE

47 Pennsylvania Ave Somerville, MA 02145

client information:

BRIAN TAMM & NANCY CAMPBELL


47 Pennsylvania Avenue Somerville, MA 02145



JOE THE ARCHITECT 343 Medford Street, Suite 4C, Somerville, MA 02145 t: +1(617) 764-3593 | e: askjoe@joethearchitect.com


www.joethearchitect.com

drawing title FIRST FLOOR PLAN

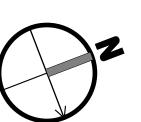

drawing scale approver As indicated | Approver drawing number

1 SECOND FLOOR PLAN 3/8" = 1'-0"

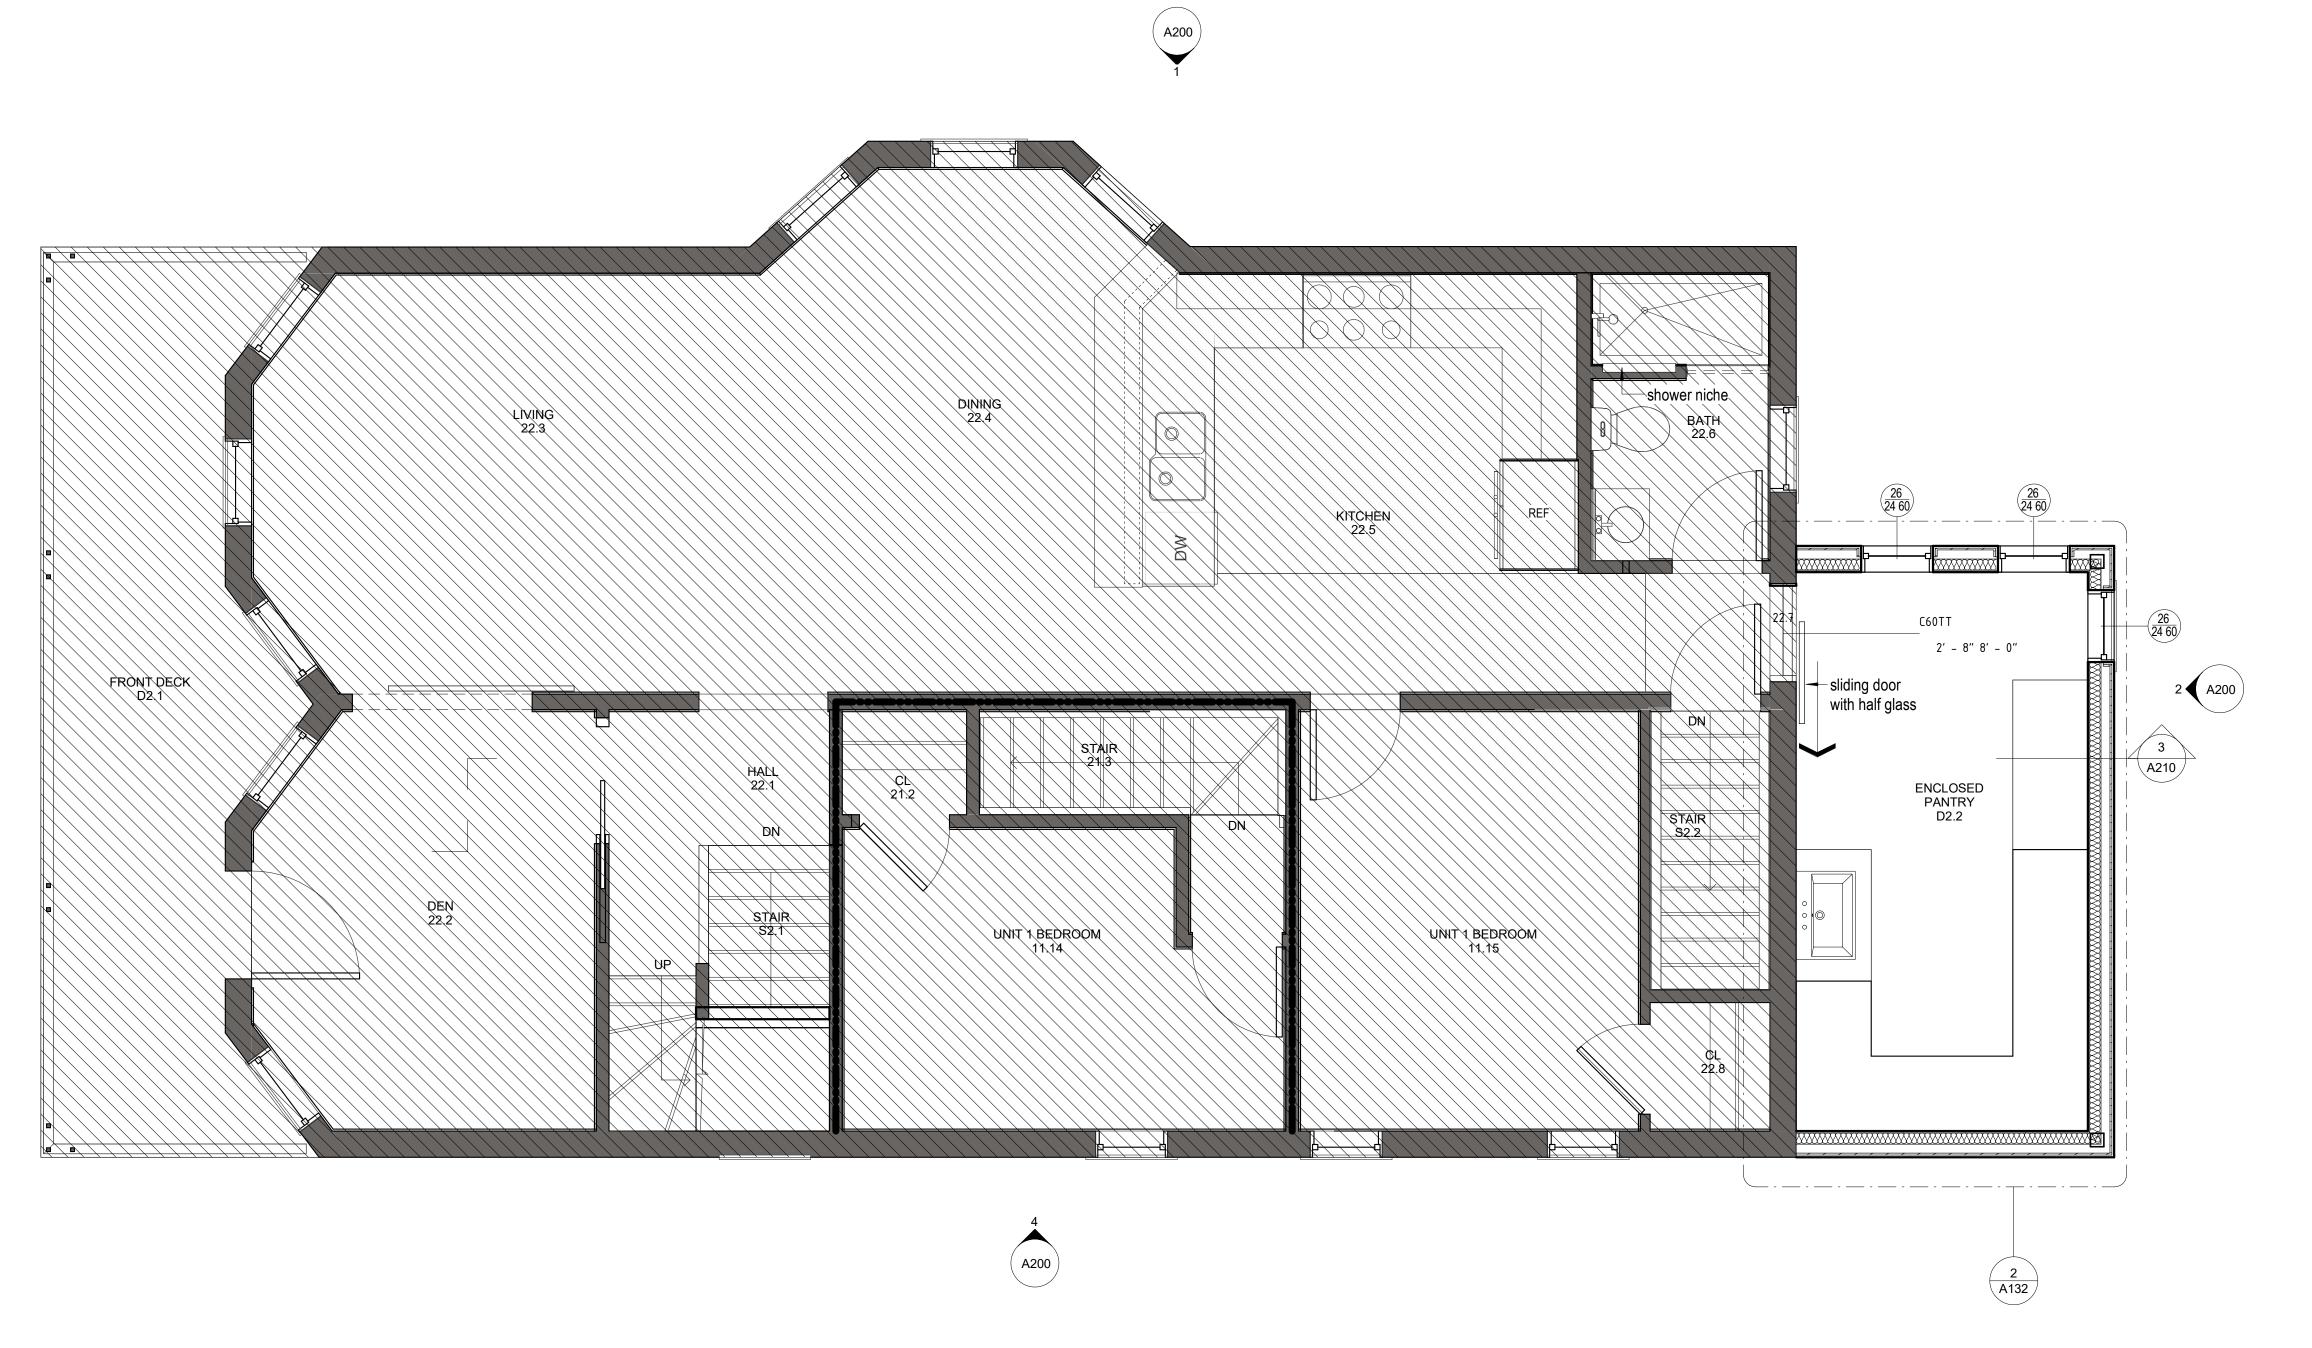

Construction Notes

- 1. See sheet A001 for abbreviations and typical
- mounting heights.
 2. See sheet A440 for partition type schedule and
- information 3. Use type GWB on fire rated partitions.
- 4. Keep door frames 4" clear on hinge side at all partition intersections except at columns where clearance is provided for hardware. 5. Use cementitious backer board ('Durock') or equal at
- partitions scheduled to receive tile. See finish plan for location of tile.
- 6. Where furred partitions exceed maximum height, brace to adjacent structure. 7. Provide level 5 finish at all partitions to receive wall
- 8. Provide level 4 finish at all interior partitions.
- 9. Provide flush drywall type access panels in partitions as required for service of building systems.
- 10. Dimensioning: All partition dimensions shown are to face of finish. - Dimensions noted as "CLEAR." mean clear dimension to face of finish. -Dimensions noted as "R.O." mean dimension of clear rough opening between studs. - All horizontal dimensions are shown on plans and vertical dimensions on interior & exterior elevations where relevant. - Vertical dimensions are too top of subfloor. See door schedule for door sizes, frame and details.
- 11. Align vertically & horizontally electrical wall devices including switches, outlets, fire alarm devices, exit signs, emergency lights, etc. When possible within code requirements, and where near each other.
- 12. See RCP for info regarding ceiling type finish, fixtures and all ceiling information.
- 13. Provide blocking and backing as required within existing partitions and new partitions for all casework, shelving, countertops, toilet accessories, and owner supplied toilet accessories, and owner supplied equipment. Coordinate with shop drawings.
- 14. Maintain integrity of existing fire resistant rated assemblies for all penetrations.
- 15. Use water resistance GWB on all wet areas. 16. All doors on 2H rated walls to be 1 1/2" rated door.
- 17. G.C. to install acoustic insulation on all interior new 18. G.C. to coordinate all floor transition thickness with adequate floor thresholds that do not exceed 1/2"
- 19. G.C. to coordinate HVAC systems distribution with
- new lighting and ceiling layout contact architect with any conflict. 20. G.C. to keep a continuous building thermal envelop
- wall R-20, roof R-38, basement wall R-10, floor R-30. In accordance with IBC energy efficiency Chapter 11.


Construction Legend

existing full height solid, glazed or part glazed partition

existing full height solid, glazed or part glazed partition to be demolished

new full height solid, glazed or part glazed partition to be demolished === existing door to

be demolished existing wall finish to be removed, to be read in conjunction with proposed works

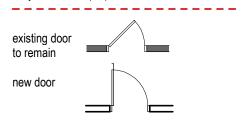

demolition hatch

RXXXXXX partial area demolition NIC - Not In Constract Hatch

For Review


WARNING:
Joe The Architect, Inc., all drawings and written material herein constitute the original and unpublished work of the architect, and the same may not be duplicated, used, or disclosed without the written consent of the architect. Contractors to use itectural drawings for set out. Contractors to check and verify all Dimensions on Site prior to Construction/Fabrication. Figured Dimensions take precedence over aled Dimensions. Any discrepancies should be immediately referred to the Architect. The project manager shall be notified in writing of any discrepancies prior o proceeding with the work. The scale of drawings may change when copied or axed. All work to comply with I.B.C. Regulations and relevant American Standards.

consultant / contractor information: D&R Construction Company

Eric Dutra

52 Berkshire St. Cambridge, MA 02141

617-378-8975 ericdutra@dandrconstructionco.com

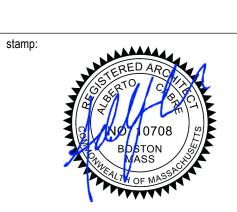

revision description 12/05/2018 Meeting Revision FOR APPROVAL 05/24/2019 FOR APPROVAL R1 07/17/2019

PENNSYLVANIA AVENUE SOMERVILLE

47 Pennsylvania Ave Somerville, MA 02145

client information: **BRIAN TAMM &** NANCY CAMPBELL


47 Pennsylvania Avenue Somerville, MA 02145



JOE THE ARCHITECT
343 Medford Street, Suite 4C, Somerville, MA 02145
t: +1(617) 764-3593 | e: askjoe@joethearchitect.com


www.joethearchitect.com

drawing title SECOND FLOOR PLAN

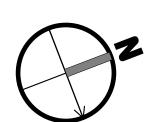

drawing scale approver As indicated | Approver drawing number

1 THIRD FLOOR PLAN
3/8" = 1'-0"

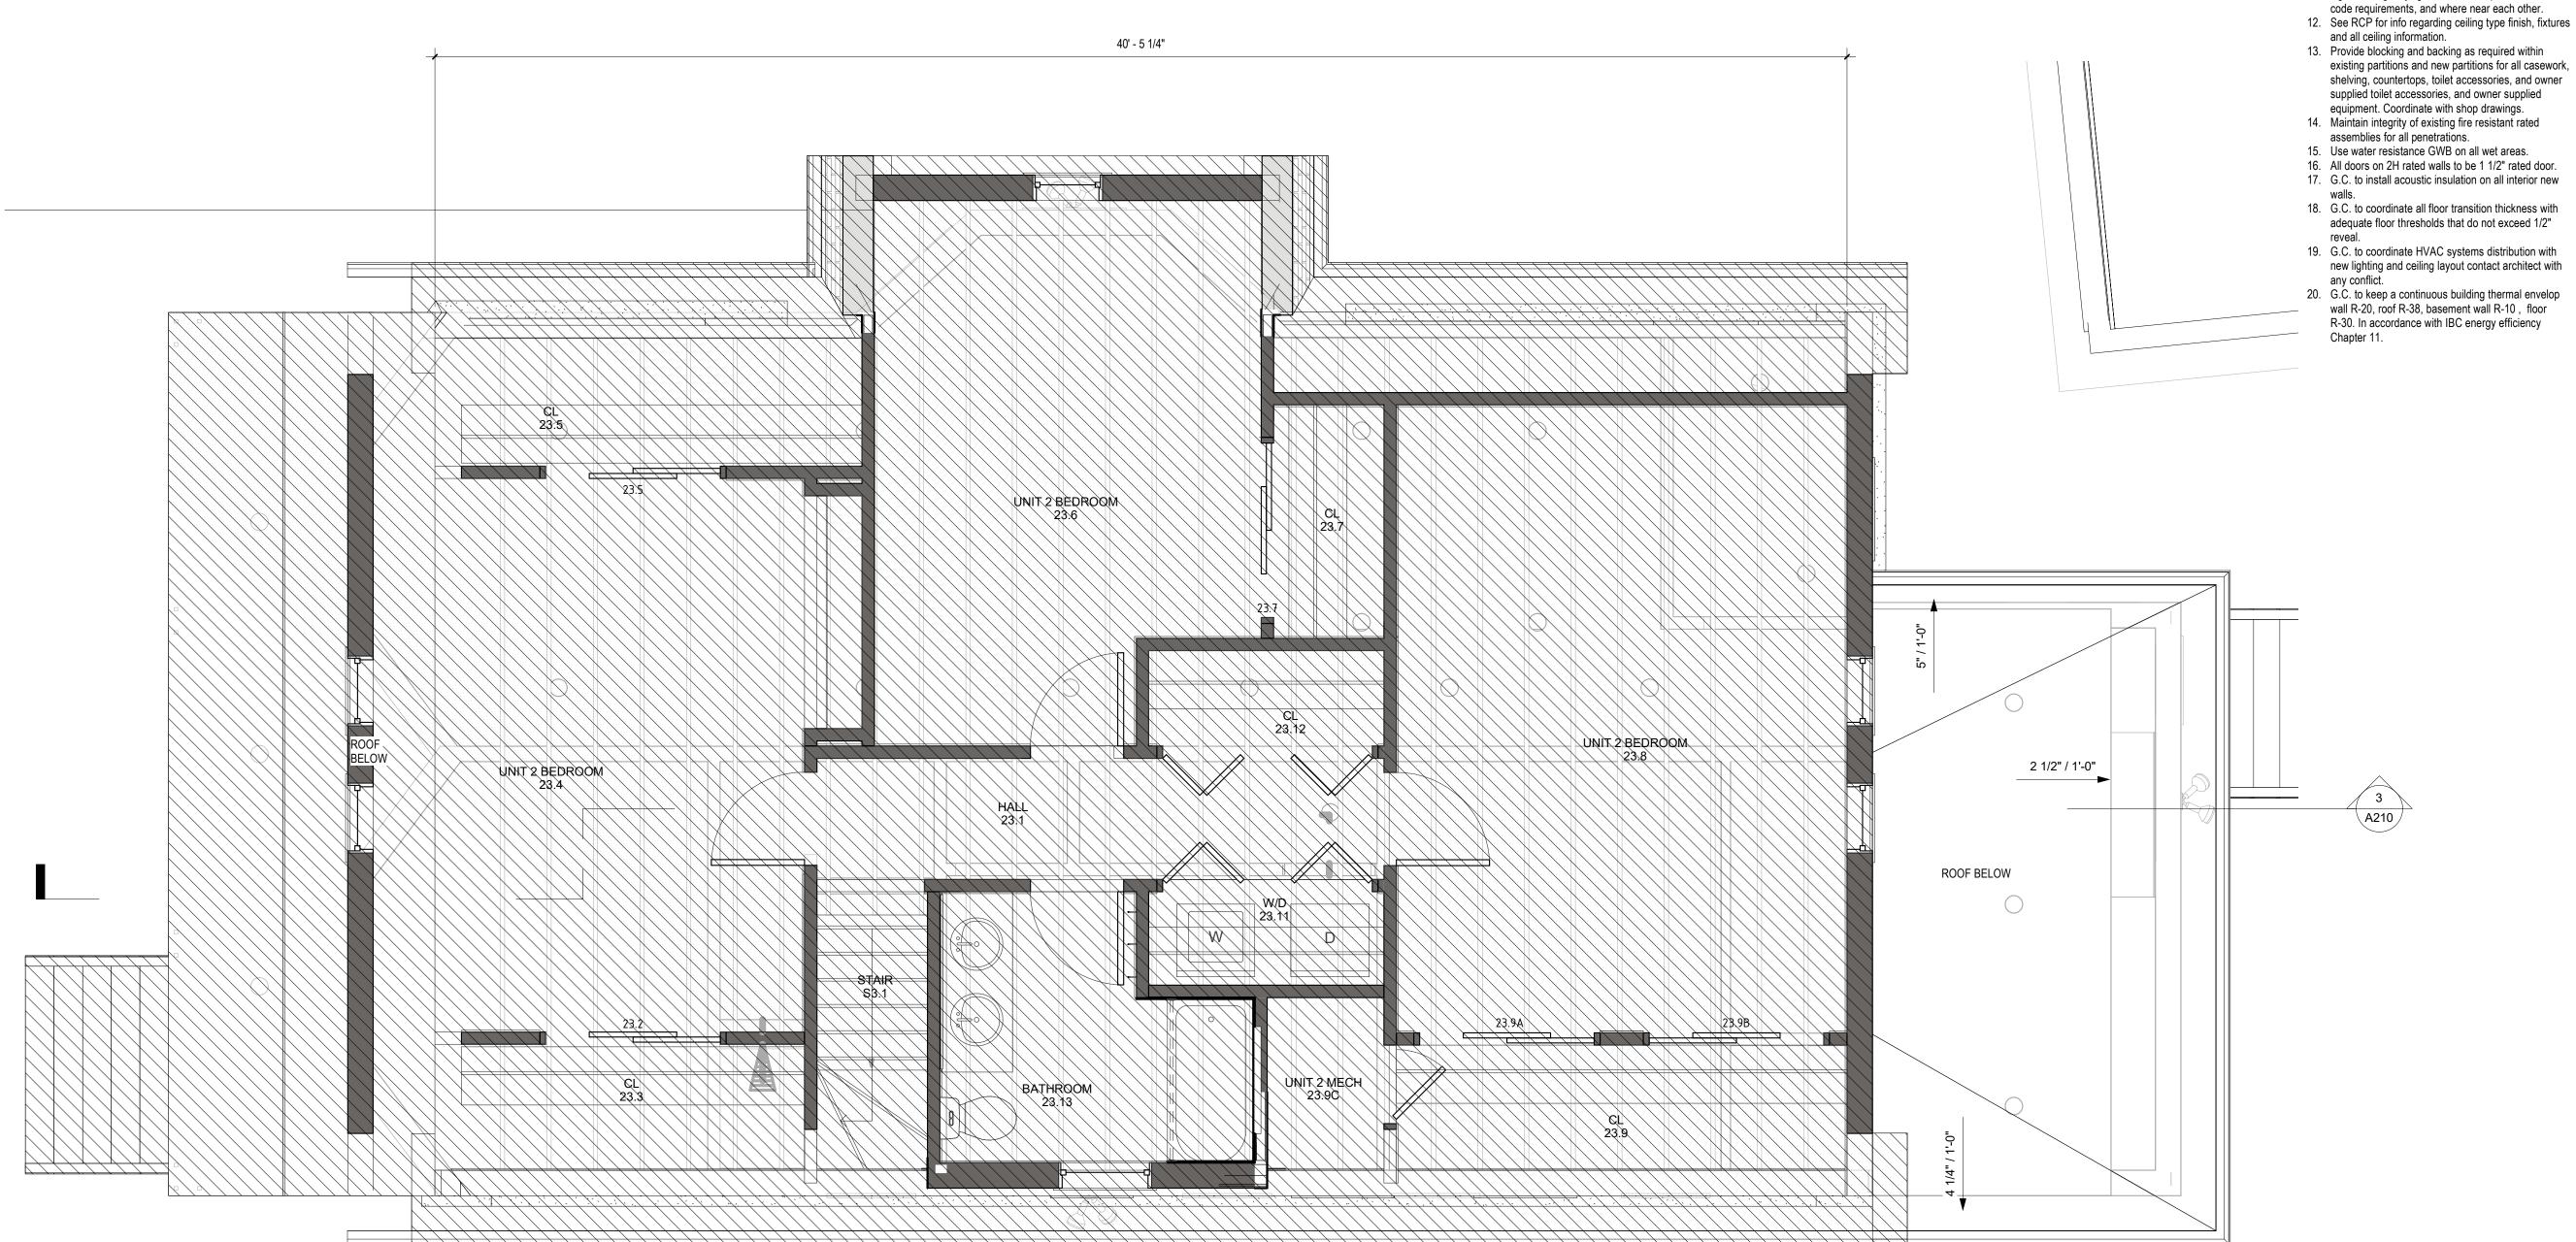

Construction Notes

- 1. See sheet A001 for abbreviations and typical
- mounting heights.
 2. See sheet A440 for partition type schedule and
- 3. Use type GWB on fire rated partitions. 4. Keep door frames 4" clear on hinge side at all
- partition intersections except at columns where clearance is provided for hardware. 5. Use cementitious backer board ('Durock') or equal at partitions scheduled to receive tile. See finish plan for
- location of tile. 6. Where furred partitions exceed maximum height, brace to adjacent structure.
- 7. Provide level 5 finish at all partitions to receive wall
- covering.

 8. Provide level 4 finish at all interior partitions.
- 9. Provide flush drywall type access panels in partitions as required for service of building systems. 10. Dimensioning: All partition dimensions shown are to
- face of finish. Dimensions noted as "CLEAR." mean clear dimension to face of finish. -Dimensions noted as "R.O." mean dimension of clear rough opening between studs. - All horizontal dimensions are shown on plans and vertical dimensions on interior & exterior elevations where relevant. - Vertical dimensions are too top of subfloor. See door schedule for door sizes, frame and details.
- 11. Align vertically & horizontally electrical wall devices including switches, outlets, fire alarm devices, exit signs, emergency lights, etc. When possible within
- 13. Provide blocking and backing as required within existing partitions and new partitions for all casework, shelving, countertops, toilet accessories, and owner
- equipment. Coordinate with shop drawings. 14. Maintain integrity of existing fire resistant rated
- 16. All doors on 2H rated walls to be 1 1/2" rated door.
- 18. G.C. to coordinate all floor transition thickness with adequate floor thresholds that do not exceed 1/2"
- 19. G.C. to coordinate HVAC systems distribution with new lighting and ceiling layout contact architect with
- 20. G.C. to keep a continuous building thermal envelop wall R-20, roof R-38, basement wall R-10, floor R-30. In accordance with IBC energy efficiency

axed. All work to comply with I.B.C. Regulations and relevant American Standards. consultant / contractor information:

D&R Construction Company

Eric Dutra 52 Berkshire St. Cambridge, MA 02141 617-378-8975

WARNING:
Joe The Architect, Inc., all drawings and written material herein constitute the

original and unpublished work of the architect, and the same may not be duplicated, used, or disclosed without the written consent of the architect. Contractors to use

aled Dimensions. Any discrepancies should be immediately referred to the

rchitect. The project manager shall be notified in writing of any discrepancies prior proceeding with the work. The scale of drawings may change when copied or

itectural drawings for set out. Contractors to check and verify all Dimensions on Site prior to Construction/Fabrication. Figured Dimensions take precedence over

Construction Legend

to be demolished

be demolished

existing door to

be demolished

conjunction with proposed works

_

existing door

to remain

new door

demolition hatch

partial area demolition

NIC - Not In Constract Hatch

existing full height solid, glazed or part glazed partition

existing full height solid, glazed or part glazed partition


new full height solid, glazed or part glazed partition to

existing wall finish to be removed, to be read in

 $\mathbb{Z} \times \mathbb{Z} \times \mathbb{Z} \times \mathbb{Z}$

For Review

ericdutra@dandrconstructionco.com

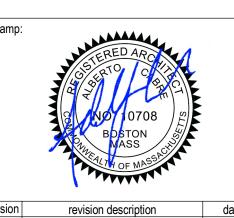

 101101011 000011011011	440	
Meeting Revision	12/05/2018	
FOR APPROVAL	05/24/2019	
FOR APPROVAL R1	07/17/2019	

PENNSYLVANIA AVENUE SOMERVILLE

47 Pennsylvania Ave Somerville, MA 02145

client information: **BRIAN TAMM &** NANCY CAMPBELL


47 Pennsylvania Avenue Somerville, MA 02145



JOE THE ARCHITECT 343 Medford Street, Suite 4C, Somerville, MA 02145 t: +1(617) 764-3593 | e: askjoe@joethearchitect.com

www.joethearchitect.com


drawing title THIRD FLOOR PLAN

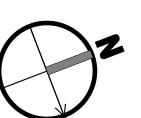


drawing scale approver As indicated | Approver

	LIGHTING FIXTURE SCHEDULE										
						Dimensions		Lamp			
Type Mark	Count	t Description	Manufacturer	Model	W	D	Н	No. Type Watts	Control	Mounting	Remark
CF1	2	Ceiling Fan w/ Downlight									
<u> </u>	9	Exterior Surface Mounted Downlight									
= 2	5	Portsmouth Outdoor Entrance Wall Sconce	Signature Hardware	941509	8"	8"	9"				
=L	4	Exterior Wall Mounted Flood Lights	TBD	-							
.1	6	2' LED Closet Linear Fixture									
_2	9	4' LED Closet Linear Fixture									
LED1	6	LED Under Cabinet Strip									
P1	3	Colorful Warehouse Loft Shade Pendant - Gray	Shades Of Light	PE09061A GY	16"	16"	8.5"				
2	3	Truncated Cone Shade Pendant - Small	Shades Of Light	PE18064 BP	10"	10"	8.5"				
23	1	Clear Glass Sphere Chandiler	Shades Of Light	CH13114A PN	17"	17"	16"				
7 1	34	Recessed Light									
R2	8	Recessed Light Wet Location									
₹3	8	Recessed Light Directional Downlight									
S1	2	1 - Light Semi Flush Mount	Stonecrest	LFMF3862	10"	10"	6"				
S2	6	Replay 2 - Light Flushmount w/ Etched White Glass	Progress Lighting	P3423-31	14"	14"	6"				
S3	4	Iconic Color Pop Dome Ceiling Light - Small - Navy	Shades Of Light	FM18013S NV	11"	11"	5"				
64	3	Mod Mix White Globe Semi-Flush Ceiling Light - Large - Satin Brushed Nickel White	Shades Of Light	FM18169 SN	8"	8"	11"				
S5	3	Sleek Cylinder Ceiling Light - Large	Shades Of Light	FM15042 BN							
SM1	8	Surface Mounted Linear Fixture									
W1	1	Geneva 1 - Light Chrome Rectangle Vanity Light Bar	Access Lighting	31011-CH/OPL	36.6"	3.5"	4"				
N2	1	Minimalist Edison 2 - Light Sconce	Shades Of Light	BS13058	14.5"	5"	5"				
W3	1	Eldered Vanity Sconce - Single LED Light - Brushed Nickel	Signature Hardware	428018	24"	3.5"	5.5"				
XF1	2	Bathroom Exhaust Fan									1

1 SECOND FLOOR REFLECTED CEILING 3/8" = 1'-0"

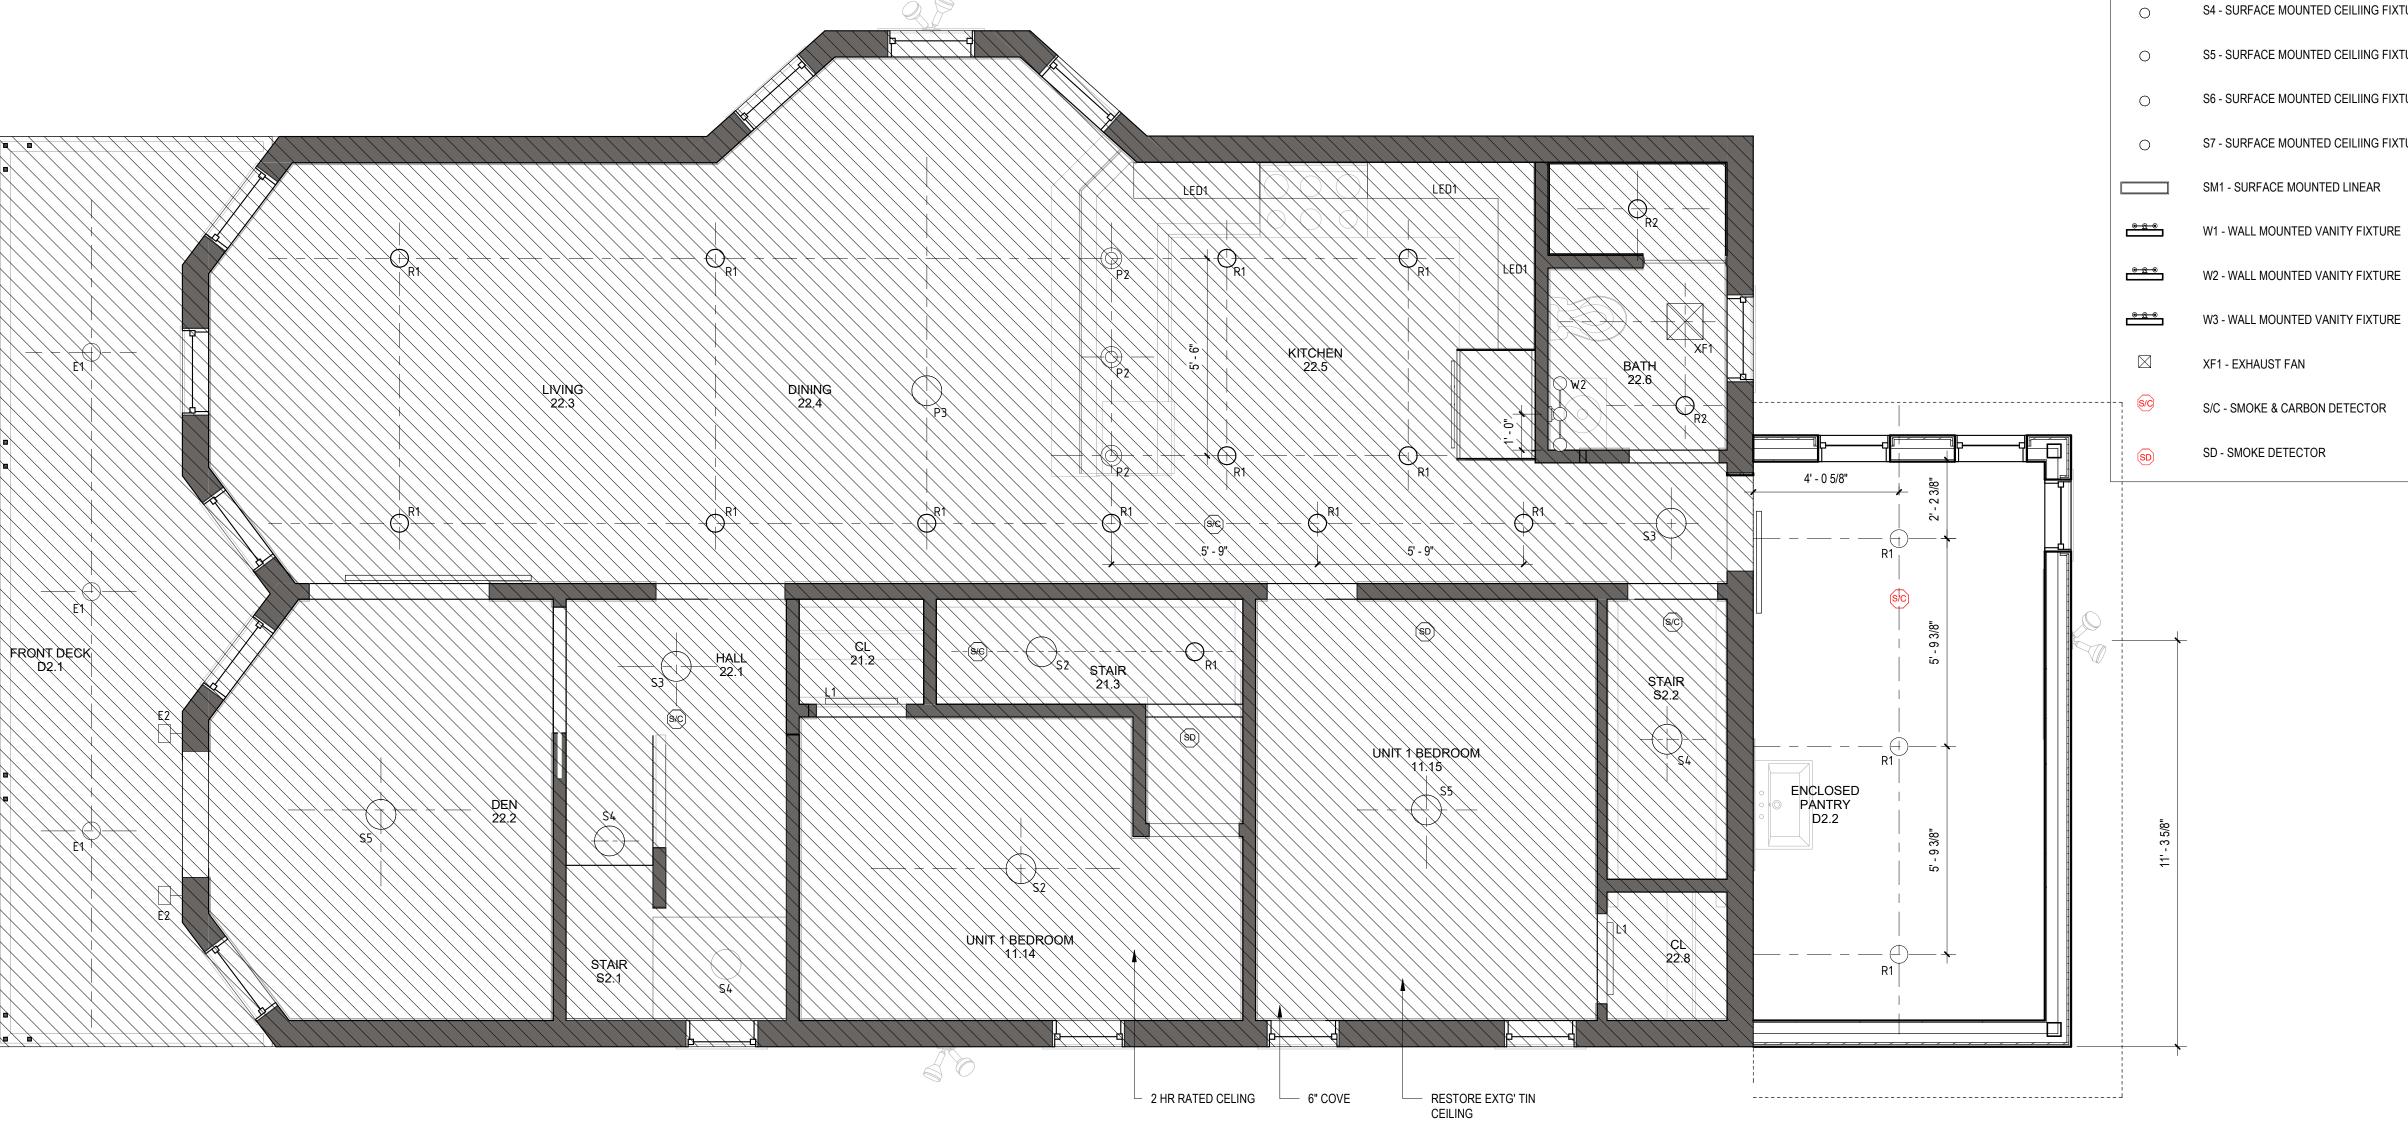

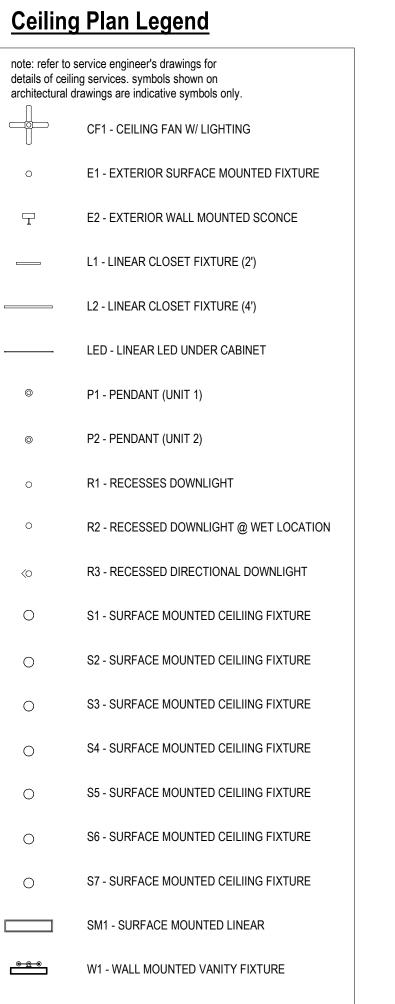

W2 - WALL MOUNTED VANITY FIXTURE

S/C - SMOKE & CARBON DETECTOR

XF1 - EXHAUST FAN

SD - SMOKE DETECTOR

Reflected Ceiling Notes

2. all lighting, mechanical and fire services shown on the reflected ceiling plan are indicative

3. ceiling heights are taken from the slab level in

6. refer to engineers drawings and specifications

for scope of sprinklers and fire suppression

7. location of ceiling set outs to be provided

8. bleacher soffit ce5 to have cavity completely

9. contractor to comply with the ibc and local state building code, and all relevant codes, in accordance with the fire rating of all mechanical

services where applicable; including vertical and horizontal applications. all fire rating to these services to occur within ceiling cavity for horizontal

10. all ceilings @ first floor to have x2 layers of

oe The Architect, Inc., all drawings and written material herein constitute the

Site prior to Construction/Fabrication. Figured Dimensions take precedence over

caled Dimensions. Any discrepancies should be immediately referred to the

Architect. The project manager shall be notified in writing of any discrepancies prior to proceeding with the work. The scale of drawings may change when copied or faxed. All work to comply with I.B.C. Regulations and relevant American Standards. © 2019- all rights reserved

52 Berkshire St. Cambridge, MA 02141

ericdutra@dandrconstructionco.com

consultant / contractor information: D&R Construction Company

Eric Dutra

original and unpublished work of the architect, and the same may not be duplicated, used, or disclosed without the written consent of the architect. Contractors to use hitectural drawings for set out. Contractors to check and verify all Dimensions on

For Review

applications, and within ducts for vertical applications. refer also to services consultants

during construction documentation.

filled with acoustic insulation.

documentation.

gwb for fire seperation.

4. all pendant and surface mounted lighting heights above finish floor (a.f.f.) are to be

5. mr3 - 45 pitch soffit with integrated demonstration mirror and web camera.

1. ceiling level throughout to be nominal 2850mm a.f.f.l. unless noted otherwise.

only, refer to mechanical, electrical and fire engineers drawings and documents for details of services. architectural drawings are to be used

for setout purposes only.

determined in the field.

which the room is assocated with.

12/05/2018 Meeting Revision FOR APPROVAL 05/24/2019 FOR APPROVAL R1 07/17/2019

revision description

PENNSYLVANIA AVENUE SOMERVILLE

47 Pennsylvania Ave Somerville, MA 02145

client information: **BRIAN TAMM &** NANCY CAMPBELL

47 Pennsylvania Avenue Somerville, MA 02145




JOE THE ARCHITECT 343 Medford Street, Suite 4C, Somerville, MA 02145 t: +1(617) 764-3593 | e: askjoe@joethearchitect.com www.joethearchitect.com

drawing title SECOND FLOOR REFLECTED CEILING



drawing scale approver As indicated | Approver

		FINISH SCHEDULE						
Mark	Materials	Location	Description					
BB1	Butcher Block	Unit 1 - Kitchen Counter Top						
PT0	Paint	Basement Walls						
PT1	Paint	Unit 1 - Throughout						
PT1.1	Paint	Unit 1 -Ceiling						
PT2	Paint	Unit 1 - Bathroom						
PT2.1	Paint	Unit 1 - Bathroom Ceiling						
PT3	Paint	Unit 2 - Foyer, Stairs & Hall						
PT3.1	Paint	Unit 2 -Ceiling						
PT4	Paint	Unit 2 - Den						
PT5	Paint	Unit 2 - Living Room, Dining Room & Kitchen						
PT5.1	Paint	Unti 2 - Ceiling						
PT6	Paint	Unit 2 - Bathrooms						
PT7	Paint	Unit 2 - Bedrooms						
ST1	Stone	Unit 1 - Kitchen Counter Top						
ST2	Stone	Unit 2 - Kitchen Counter Top & Enclosed Pantry Counter Top						
T1	Tile	Unit 1 - Foyer Flooring & Unit 2 - Entry Points & Enclosed Pantry Flooring						
T2	Tile	Unit 1 - Kitchen Backsplash & Bathroom Shower Walls						
T3	Tile	Unit 1 - Bathroom Flooring						
T4	Tile	Unit 2 - Kitchen Backsplash & Enclosed Pantry Backsplash						
T5	Tile	Unit 2 - Kitchen Flooring						
T6	Tile	Unit 2 - Second Floor Bathroom Walls						
T7	Tile	Unit 2 - Second Floor Bathroom Flooring						
T8	Tile	Unit 2 - Third Floor Bathroom Walls						
T9	Tile	Unit 2 - Third Floor Bathroom Flooring						
WB	Baseboard	Throughout						
WD0	Wood Exterior Decking	Unit 1 & Unit 2 - Exterior Deck Front & Rear						
WD1	Wood Floor	Unit 1 - Throughout Including Stair						
WD2	Wood Floor	Unit 2 - Throughout Including Stair						

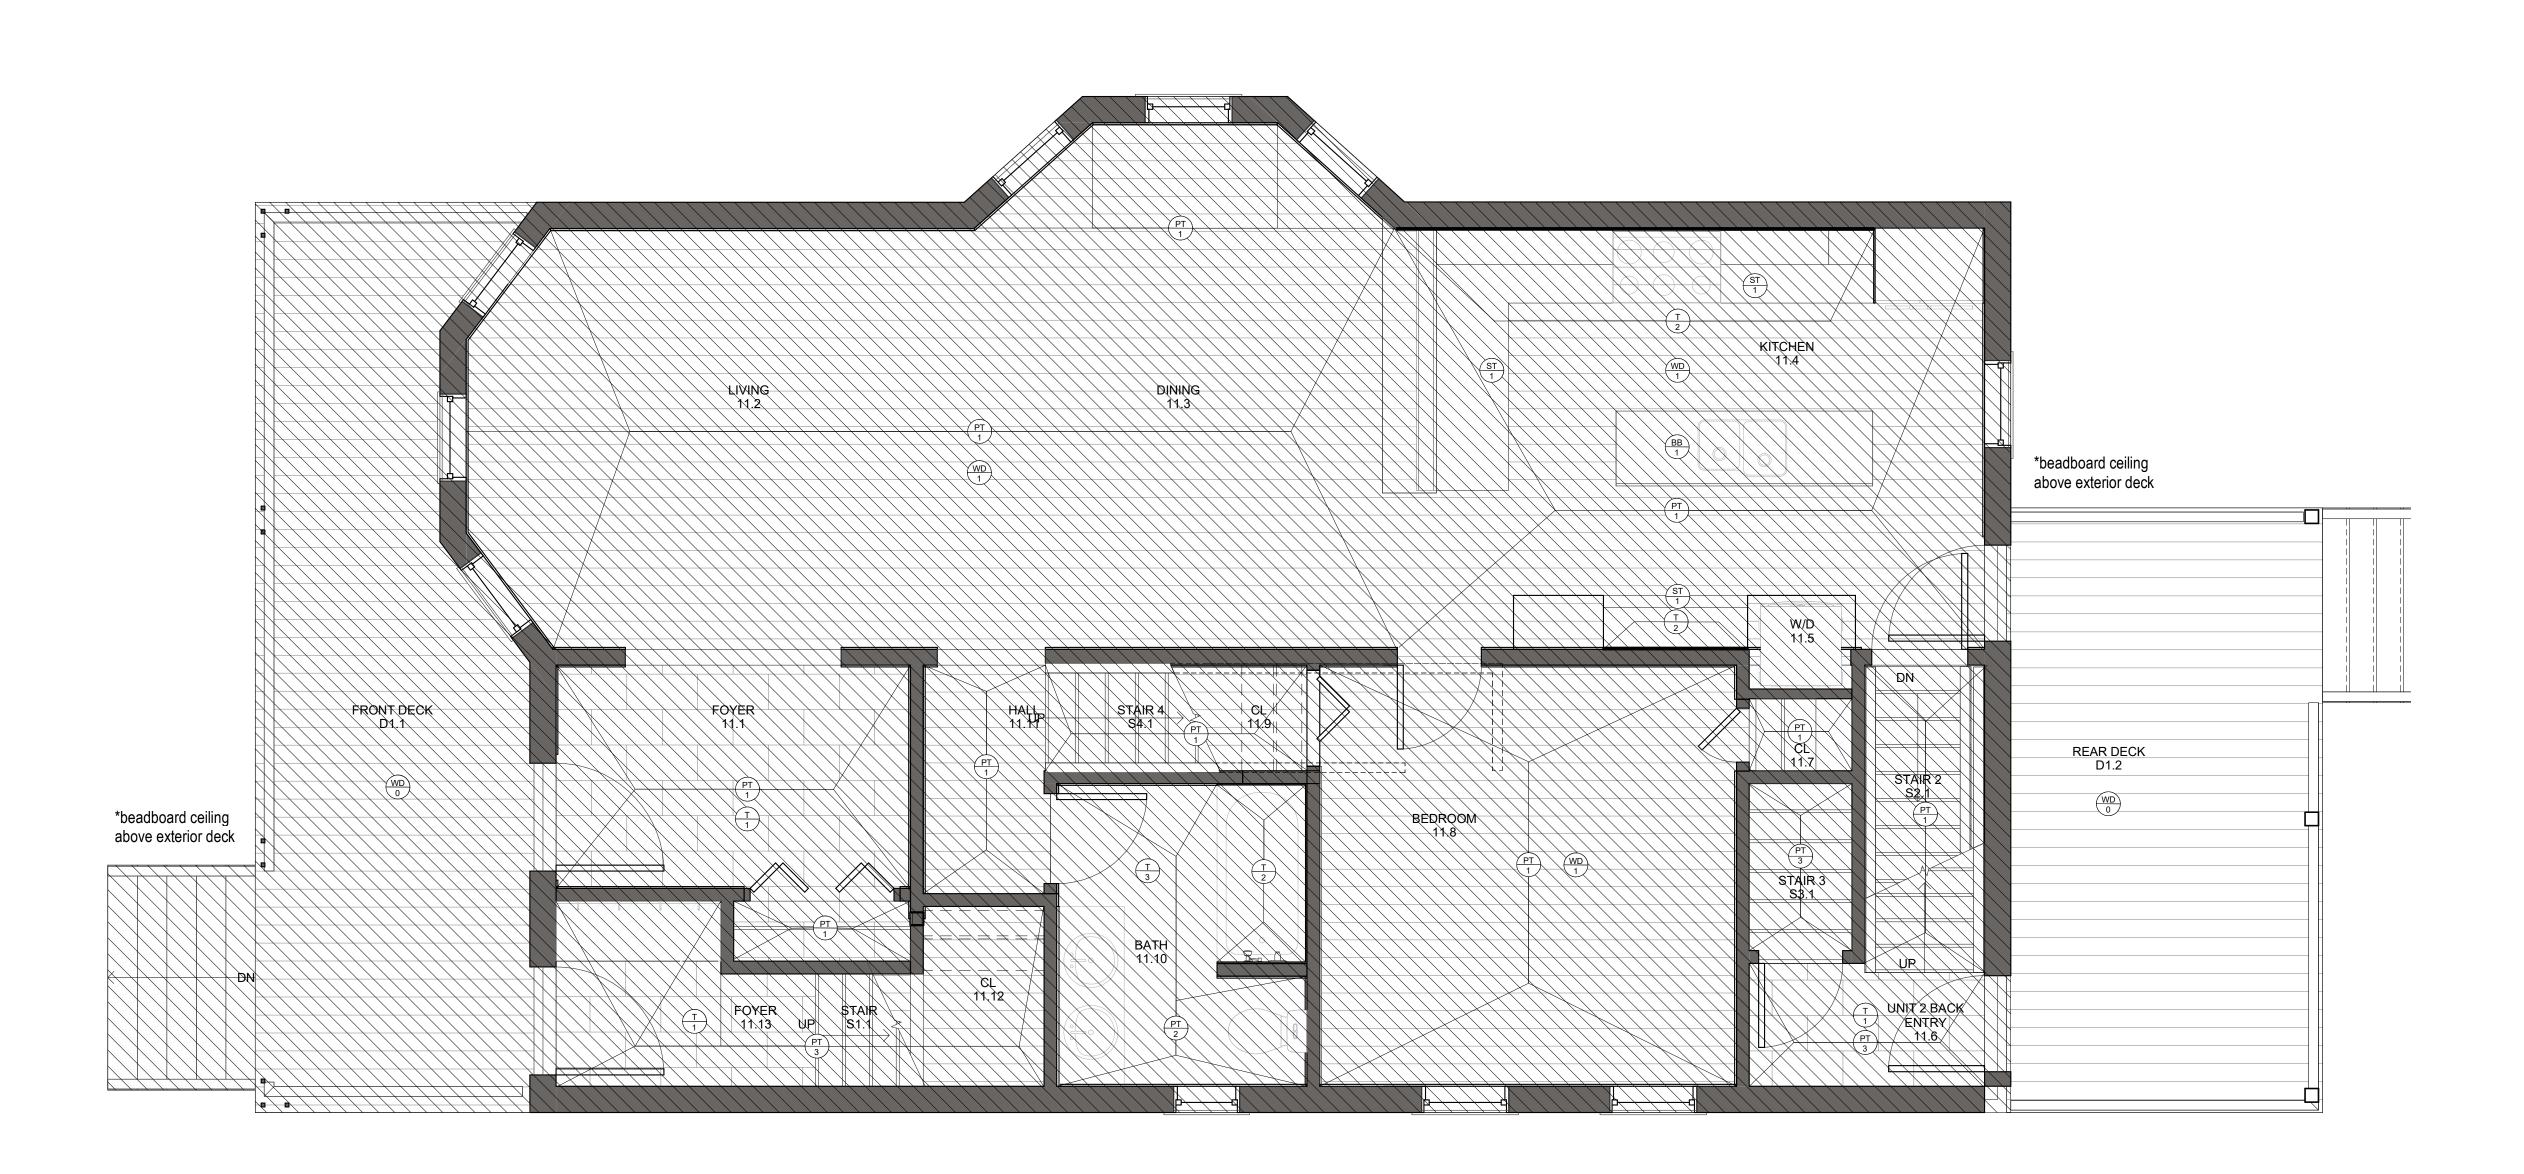

For Review

WARNING:


Joe The Architect, Inc., all drawings and written material herein constitute the original and unpublished work of the architect, and the same may not be duplicated, used, or disclosed without the written consent of the architect. Contractors to use Architectural drawings for set out. Contractors to check and verify all Dimensions on Site prior to Construction/Fabrication. Figured Dimensions take precedence over Scaled Dimensions. Any discrepancies should be immediately referred to the Architect. The project manager shall be notified in writing of any discrepancies prior to proceeding with the work. The scale of drawings may change when copied or faxed. All work to comply with I.B.C. Regulations and relevant American Standards. © 2019- all rights reserved

consultant / contractor information:

D&R Construction Company

Eric Dutra 52 Berkshire St. Cambridge, MA 02141 617-378-8975

ericdutra@dandrconstructionco.com

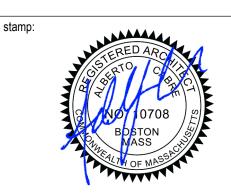

Meeting Revision	12/05/2018
FOR APPROVAL	05/24/2019
FOR APPROVAL R1	07/17/2019

oroject title:

PENNSYLVANIA AVENUE SOMERVILLE

47 Pennsylvania Ave Somerville, MA 02145

client information:
BRIAN TAMM &
NANCY CAMPBELL

47 Pennsylvania Avenue Somerville, MA 02145



JOE THE ARCHITECT 343 Medford Street, Suite 4C, Somerville, MA 02145 t: +1(617) 764-3593 | e: askjoe@joethearchitect.com www.joethearchitect.com

drawing title
FIRST FLOOR FINISH
PLAN



project number drawing scale approver


116 3/8" = 1'-0" Approver

drawing number revision

A131

1 FIRST FLOOR FINISH PLAN
3/8" = 1'-0"

		FINISH SCHEDULE						
Mark	Materials	Location	Description					
BB1	Butcher Block	Unit 1 - Kitchen Counter Top						
PT0	Paint	Basement Walls						
PT1	Paint	Unit 1 - Throughout						
PT1.1	Paint	Unit 1 -Ceiling						
PT2	Paint	Unit 1 - Bathroom						
PT2.1	Paint	Unit 1 - Bathroom Ceiling						
PT3	Paint	Unit 2 - Foyer, Stairs & Hall						
PT3.1	Paint	Unit 2 -Ceiling						
PT4	Paint	Unit 2 - Den						
PT5	Paint	Unit 2 - Living Room, Dining Room & Kitchen						
PT5.1	Paint	Unti 2 - Ceiling						
PT6	Paint	Unit 2 - Bathrooms						
PT7	Paint	Unit 2 - Bedrooms						
ST1	Stone	Unit 1 - Kitchen Counter Top						
ST2	Stone	Unit 2 - Kitchen Counter Top & Enclosed Pantry Counter Top						
T1	Tile	Unit 1 - Foyer Flooring & Unit 2 - Entry Points & Enclosed Pantry Flooring						
T2	Tile	Unit 1 - Kitchen Backsplash & Bathroom Shower Walls						
T3	Tile	Unit 1 - Bathroom Flooring						
T4	Tile	Unit 2 - Kitchen Backsplash & Enclosed Pantry Backsplash						
T5	Tile	Unit 2 - Kitchen Flooring						
T6	Tile	Unit 2 - Second Floor Bathroom Walls						
T7	Tile	Unit 2 - Second Floor Bathroom Flooring						
T8	Tile	Unit 2 - Third Floor Bathroom Walls						
T9	Tile	Unit 2 - Third Floor Bathroom Flooring						
WB	Baseboard	Throughout						
WD0	Wood Exterior Decking	Unit 1 & Unit 2 - Exterior Deck Front & Rear						
WD1	Wood Floor	Unit 1 - Throughout Including Stair						
WD2	Wood Floor	Unit 2 - Throughout Including Stair						

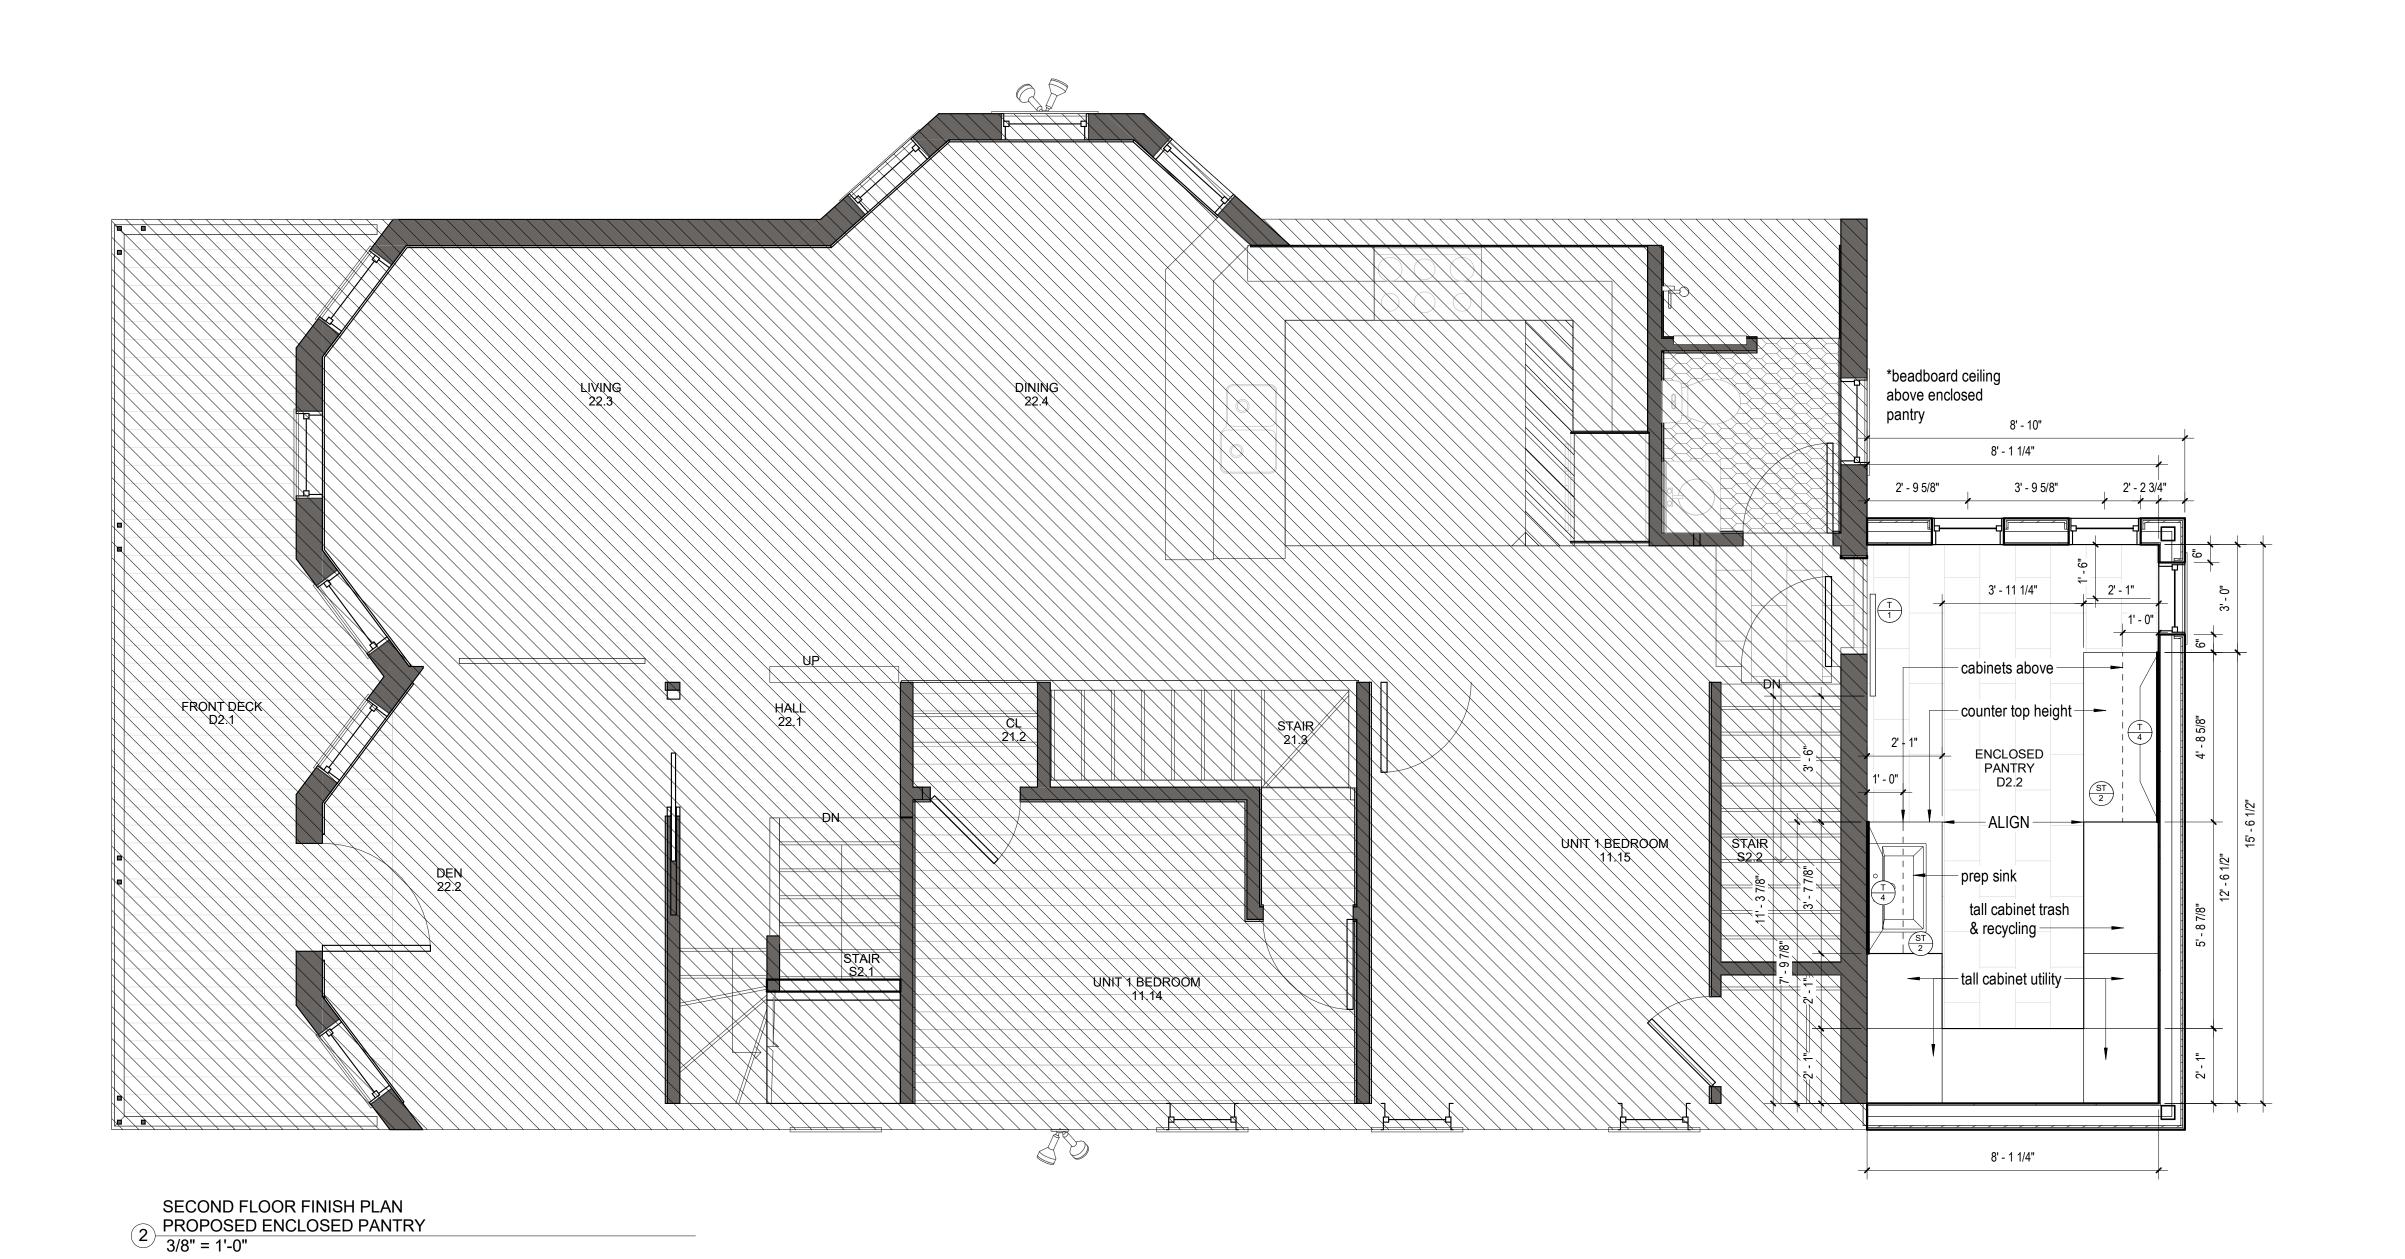



WARNING:

Joe The Architect, Inc., all drawings and written material herein constitute the original and unpublished work of the architect, and the same may not be duplicated, used, or disclosed without the written consent of the architect. Contractors to use Architectural drawings for set out. Contractors to check and verify all Dimensions on Site prior to Construction/Fabrication. Figured Dimensions take precedence over Scaled Dimensions. Any discrepancies should be immediately referred to the Architect. The project manager shall be notified in writing of any discrepancies prior to proceeding with the work. The scale of drawings may change when copied or faxed. All work to comply with I.B.C. Regulations and relevant American Standards.

© 2019- all rights reserved

consultant / contractor information:

D&R Construction Company

Eric Dutra

52 Berkshire St. Cambridge, MA 02141 617-378-8975

ericdutra@dandrconstructionco.com

•



revision description

Meeting Revision

FOR APPROVAL

FOR APPROVAL R1	07/17/20

date 12/05/2018 05/24/2019

oroject title:

PENNSYLVANIA AVENUE SOMERVILLE

47 Pennsylvania Ave Somerville, MA 02145

BRIAN TAMM & NANCY CAMPBELL


client information:

47 Pennsylvania Avenue Somerville, MA 02145



JOE THE ARCHITECT
343 Medford Street, Suite 4C, Somerville, MA 02145
t: +1(617) 764-3593 | e: askjoe@joethearchitect.com
www.joethearchitect.com

drawing title
SECOND FLOOR FINISH
PLAN

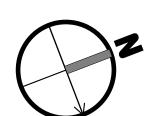

project number drawing scale approver

116 3/8" = 1'-0" Approver

drawing number A132

revision 4



drawing number

A200

For Review

05/24/2019 07/17/2019




drawing title

drawing number

BUILDING SECTIONS


drawing scale approver As indicated Approver

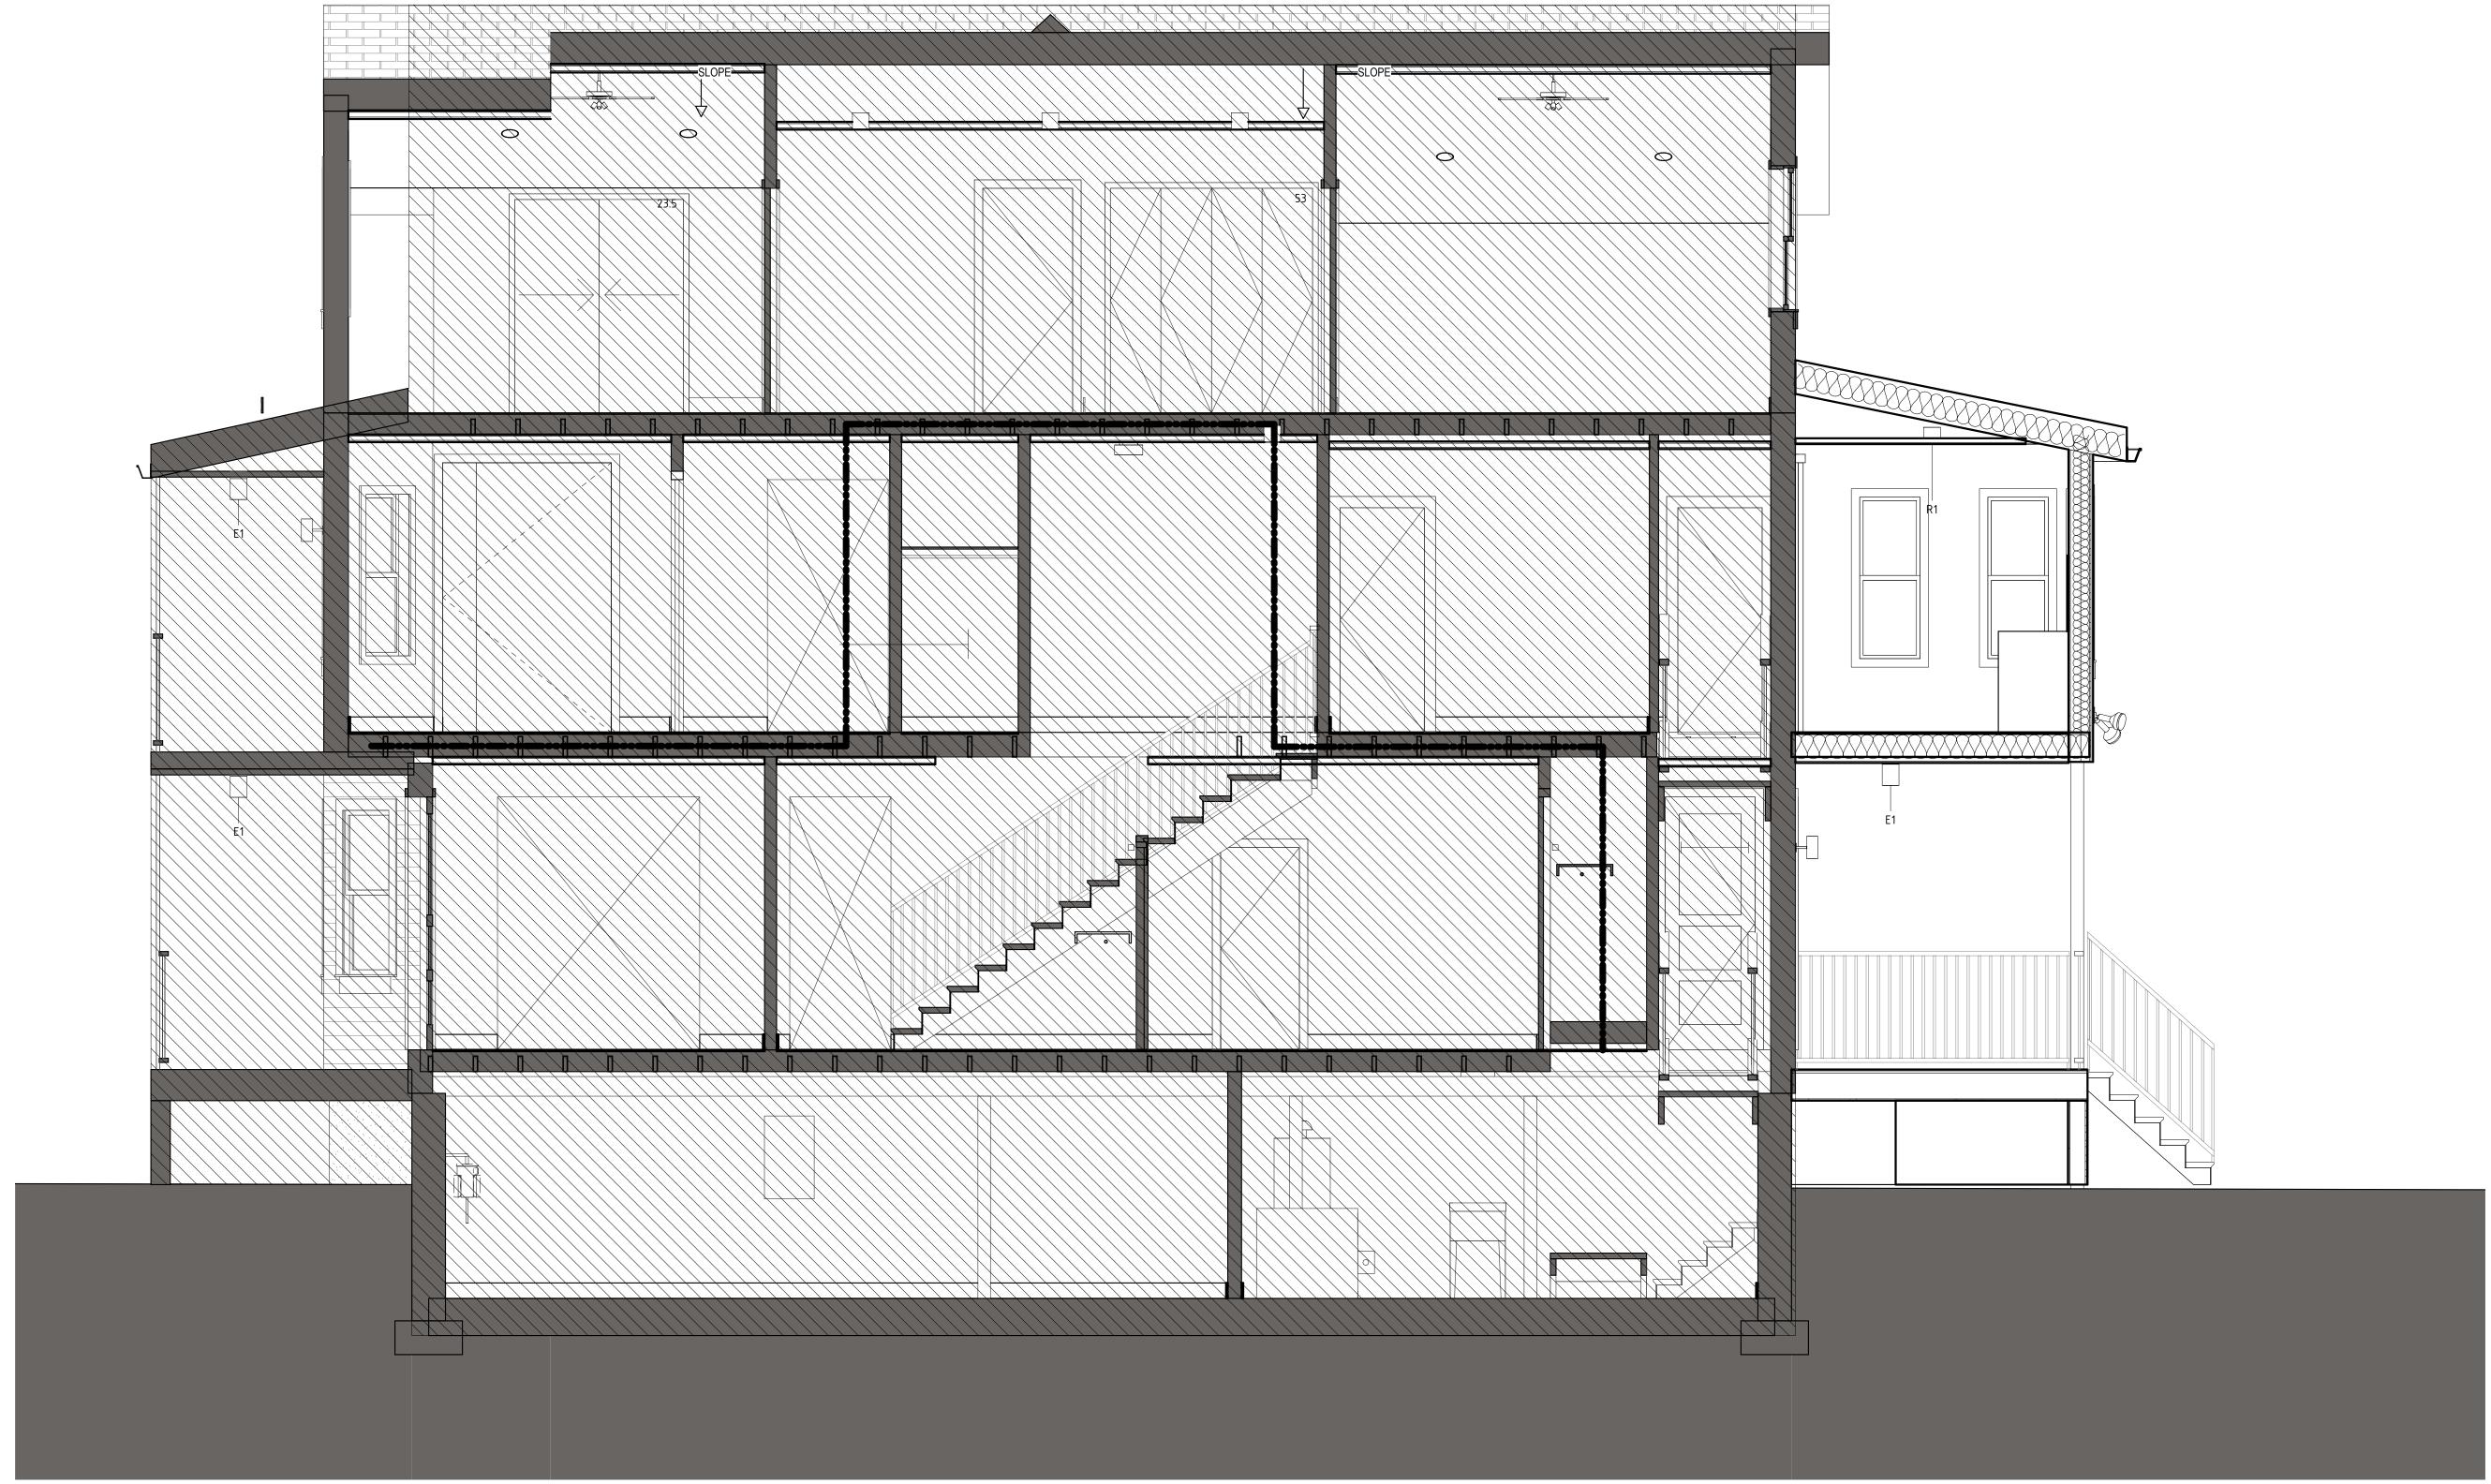


							DOOR A	AND FRAME	SCHEDULE		
						DOOR					
OPENING				PANEL							
Type Mark	Count	WIDTH	HEIGHT	R.O. WID	R.O. HGT	THICK	Double?	Unequal?	CONFIG	PANEL WIDTH	COMMENTS
	<u>'</u>	<u> </u>		'			'	-			
A32	2	2' - 8"	7' - 6"	3' - 2"	7' - 9"	0' - 0 1/2"	No	No	SINGLE		
C36	1	3' - 0"	7' - 6"	3' - 6"	7' - 9"	0' - 1 3/8"	No	No	SINGLE		
C60TT	1	2' - 8"	8' - 0"			0' - 1 3/4"					
D60	1	5' - 0"	8' - 0"			0' - 1 3/4"					

Grand total: 5

SPECIALTY EQUIPTMENT SCHEDULE						
Type Mark	Manufacturer	Model Number	Description			
			Shower Curtain Rod Exposed Mounting 1" OD 36" L			
			Shower Curtain Rod Exposed Mounting 1" OD 36" L			
			Shower Curtain Rod Exposed Mounting 1" OD 36" L			

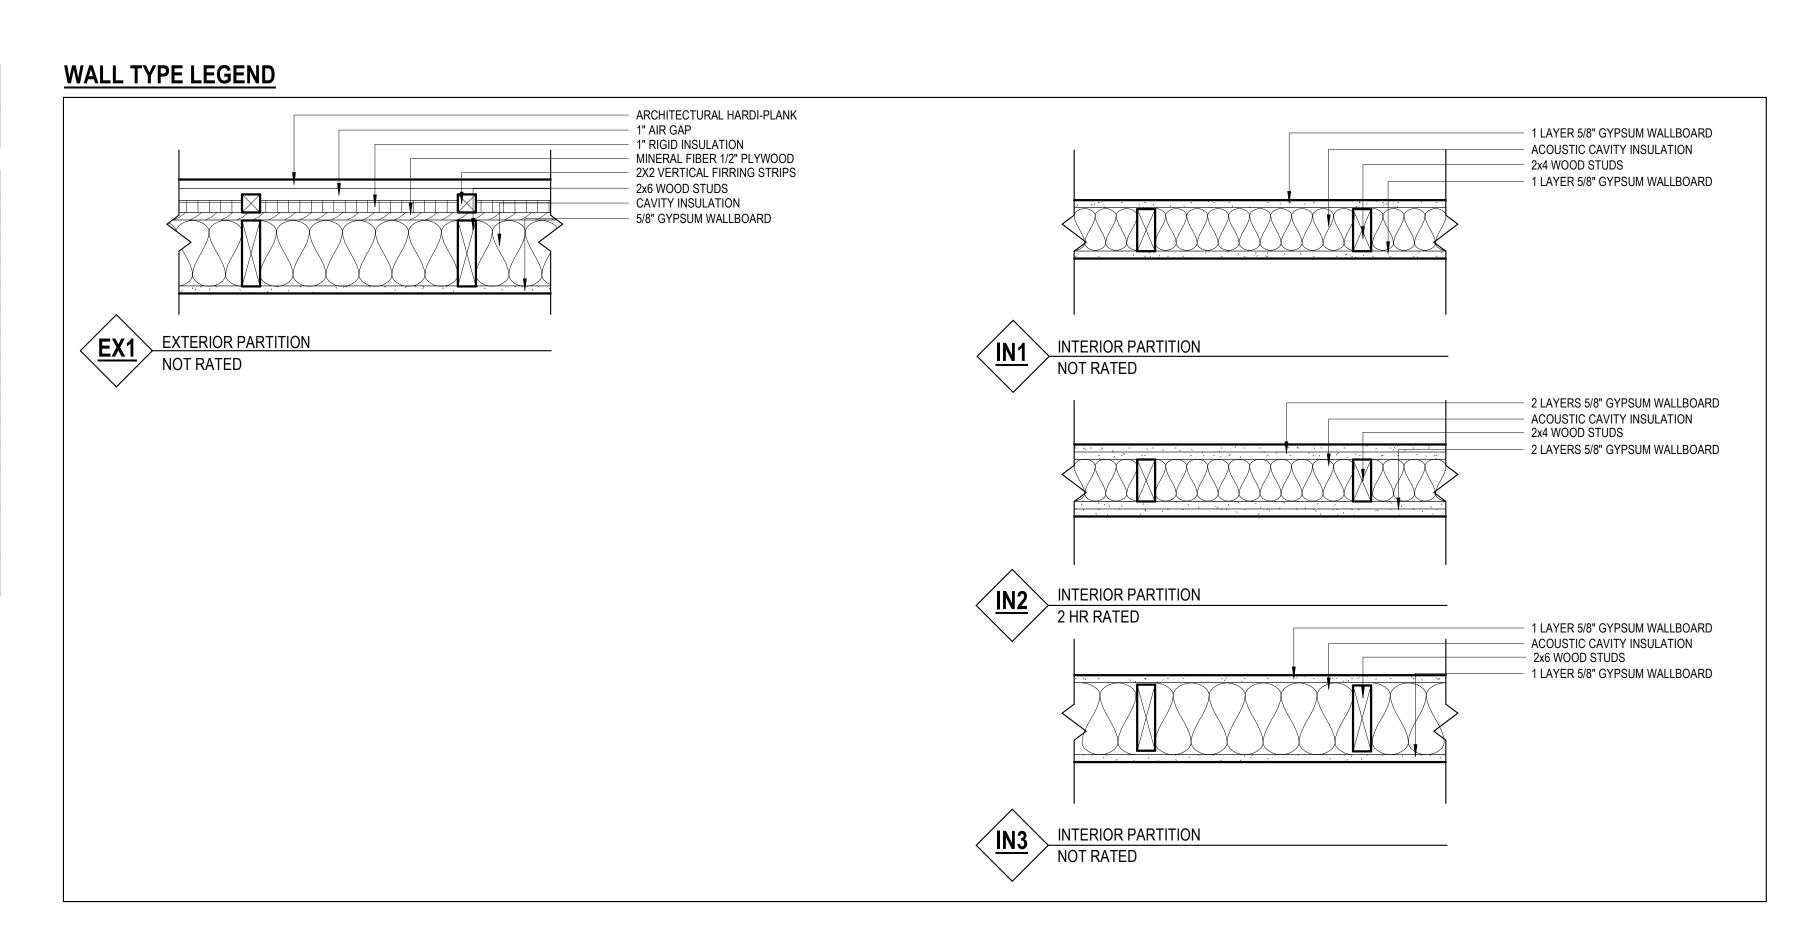

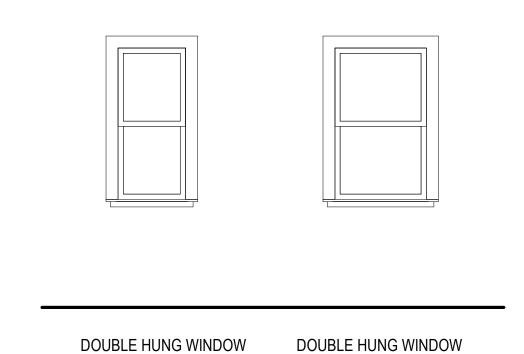

D32

Model

WINDOW SCHEDULE

MARK WIDTH HEIGHT QUANTITY TYPE Manufacturer

SIZE

26 2' - 0" 5' - 0" 3

24"x54" 32"x54" W1 W2




original and unpublished work of the architect, and the same may not be duplicated, used, or disclosed without the written consent of the architect. Contractors to use Architectural drawings for set out. Contractors to check and verify all Dimensions on Site prior to Construction/Fabrication. Figured Dimensions take precedence over Scaled Dimensions. Any discrepancies should be immediately referred to the Architect. The project manager shall be notified in writing of any discrepancies prior to proceeding with the work. The scale of drawings may change when copied or faxed. All work to comply with I.B.C. Regulations and relevant American Standards. © 2019- all rights reserved

consultant / contractor information: D&R Construction Company

Eric Dutra 52 Berkshire St. Cambridge, MA 02141

ericdutra@dandrconstructionco.com

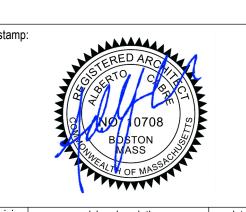

revision	revision description	date
3	FOR APPROVAL	05/24/2019
4	FOR APPROVAL R1	07/17/2019

PENNSYLVANIA AVENUE SOMERVILLE

47 Pennsylvania Ave Somerville, MA 02145 client information:

BRIAN TAMM & NANCY CAMPBELL

47 Pennsylvania Avenue Somerville, MA 02145



JOE THE ARCHITECT 343 Medford Street, Suite 4C, Somerville, MA 02145 t: +1(617) 764-3593 | e: askjoe@joethearchitect.com www.joethearchitect.com

drawing title SCHEDULES

project number	drawing scale	approver
116	As indicated	Approve
drawing number		revision